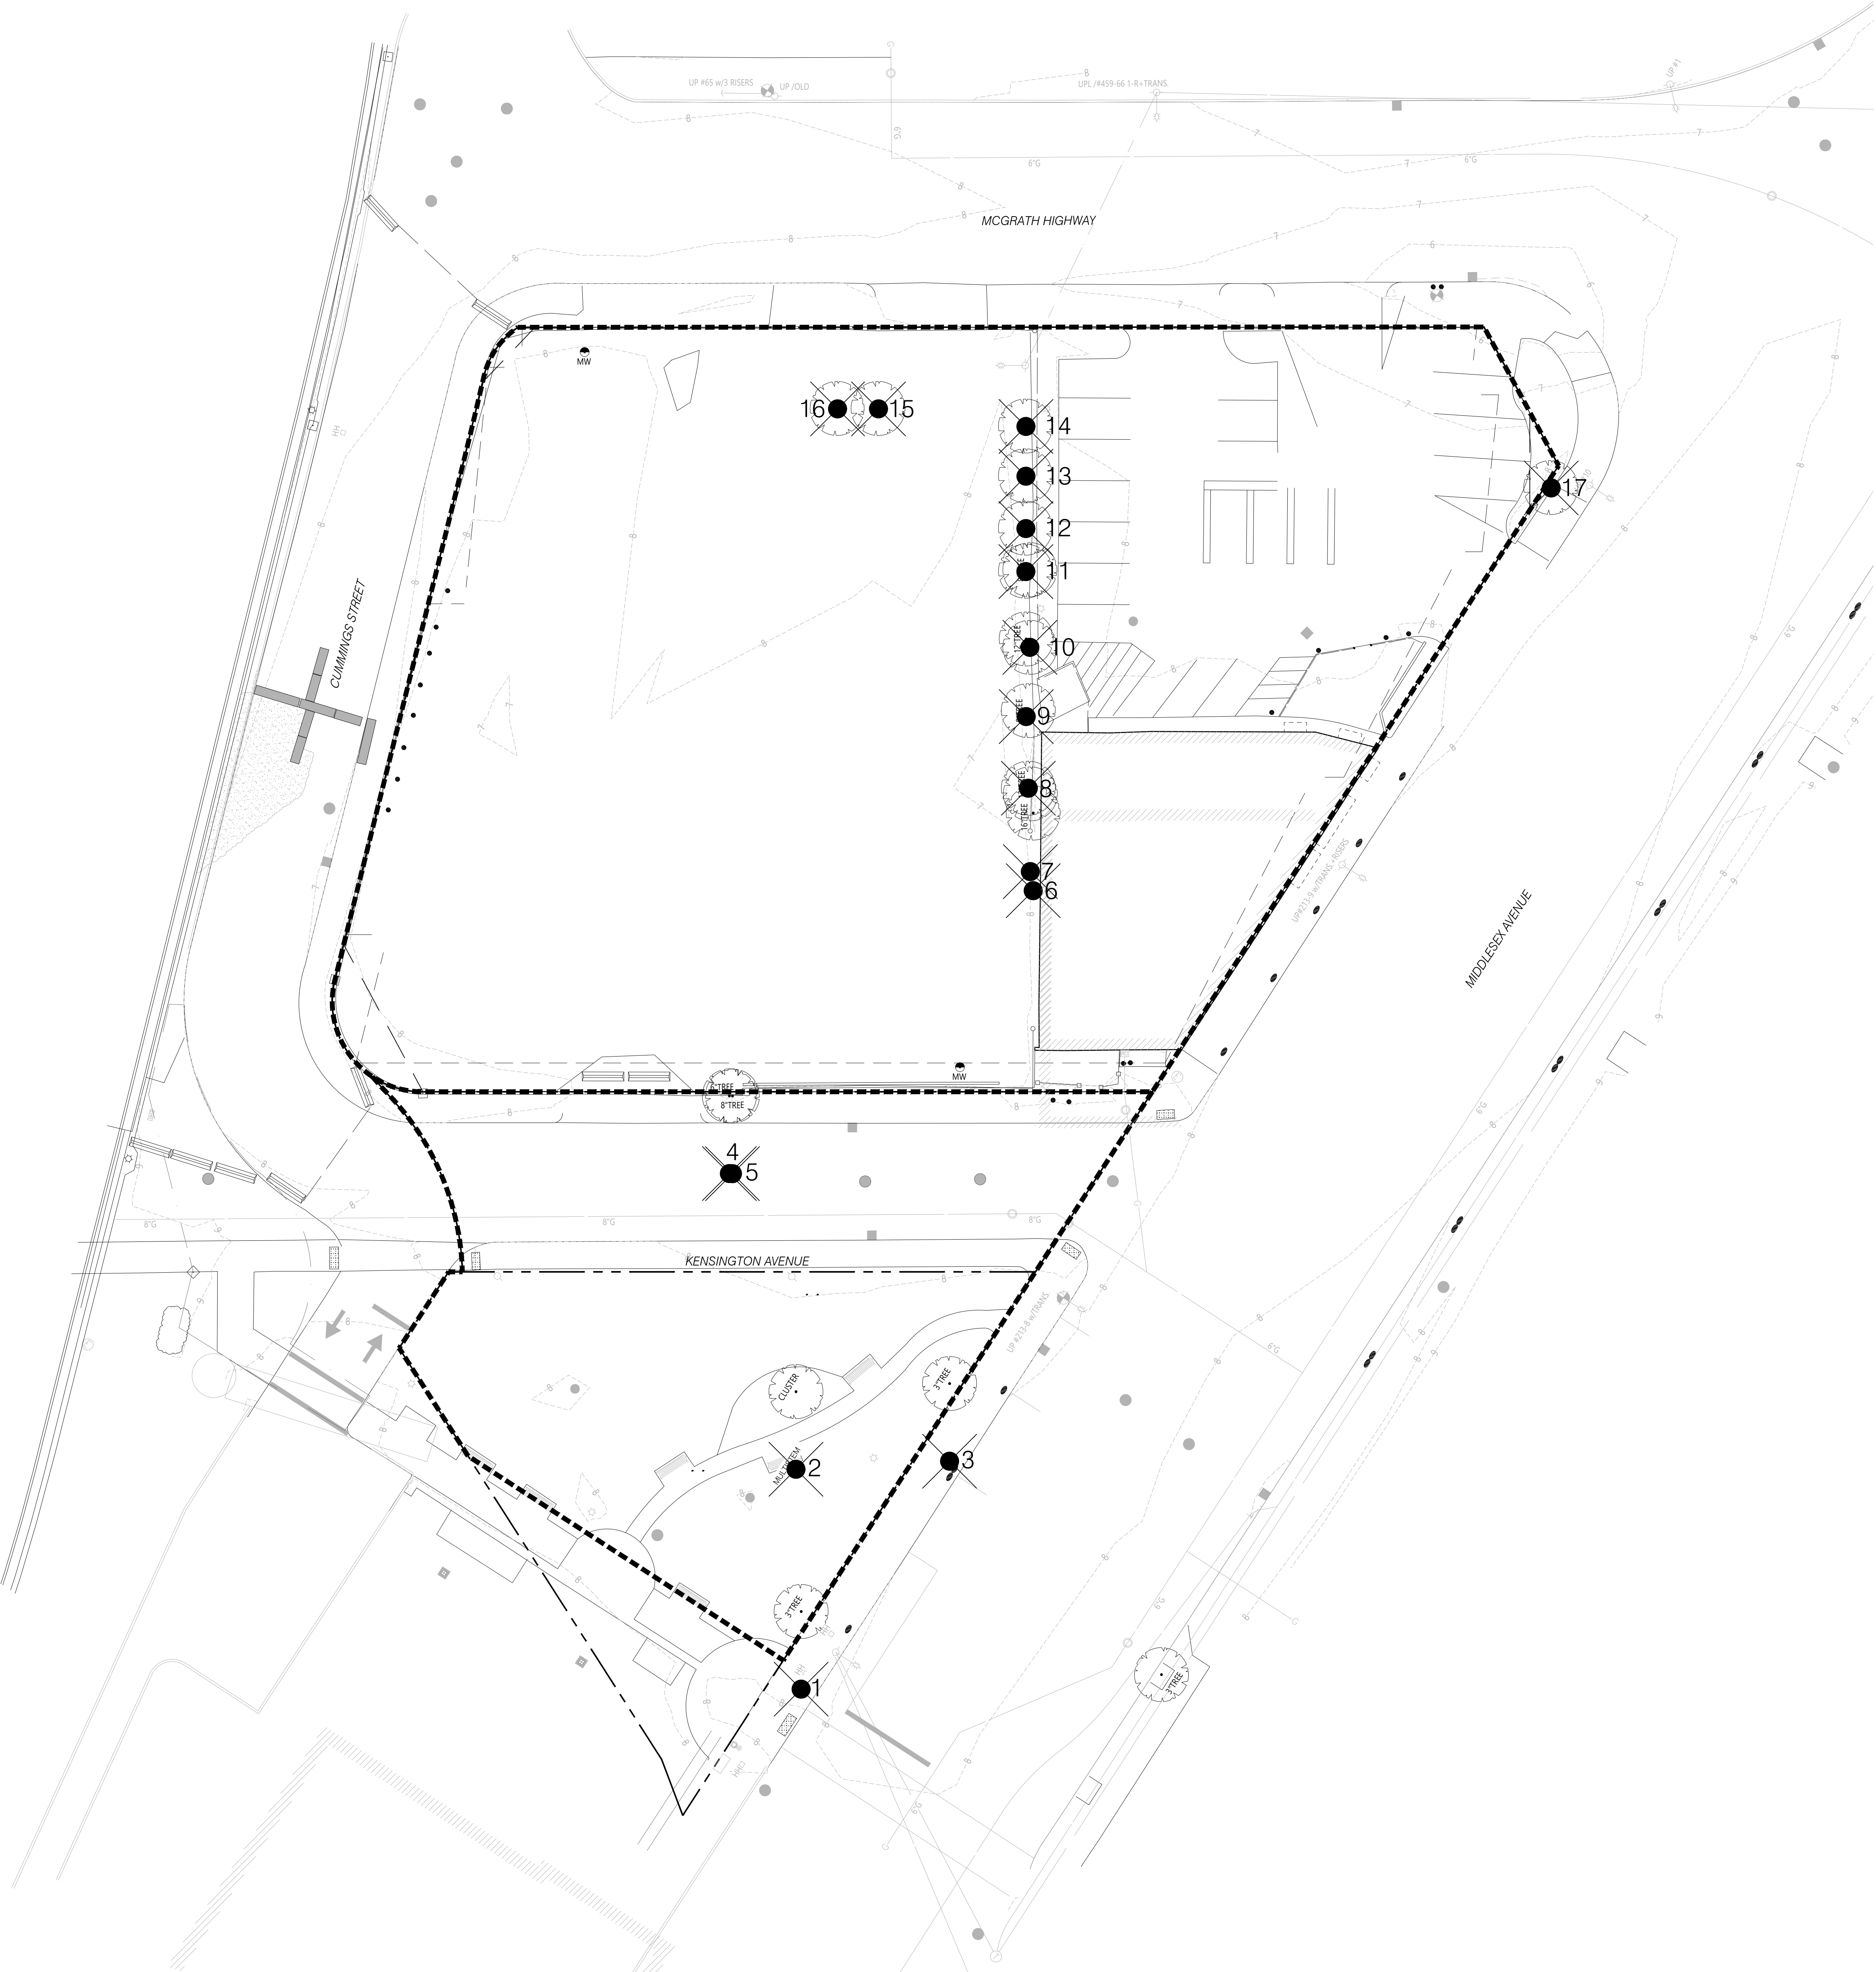


# **APPENDIX C: Green Score**

## **Contents**

- Green Score Diagram and Supporting Plans

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TREE REMOVAL PLAN LEGEND

- REMOVE EXISTING TREE AND ROOT ZONE.  
GRIND ROOT TO 3'-6" DEPTH

TREE REMOVAL PLAN NOTES

- THOROUGHLY EXAMINE AND VERIFY ALL EXISTING CONDITIONS IN THE FIELD AND REPORT ANY DISCREPANCIES TO THE LANDSCAPE ARCHITECT.
- PERFORM ALL TREE REMOVALS SO AS NOT TO DISTURB ANY EXISTING TREES TO REMAIN. IF EXISTING TREES ARE DAMAGED, CONTRACTOR TO REPLACE WITH TREE OF SAME SPECIES TO BE APPROVED BY THE LANDSCAPE ARCHITECT.

GENERAL VEGETATION CLEAN-UP & INVASIVE REMOVALS

- REVIEW ALL AREAS OF THE SITE WITHIN PROPERTY LINE AND PROVIDE GENERAL CLEAN-UP OF EXISTING VEGETATION AND REMOVAL OF ALL DEAD PLANT MATERIAL & INVASIVE SPECIES.
- CONTRACTOR TO ENGAGE LOCAL HORTICULTURISTS / BOTANIST AND AN ARBORIST TO REVIEW SITE AND PROVIDE REPORT FOR REMOVAL AND PRUNING PROTOCOL. REPORT TO BE PROVIDED TO LA AND OWNER FOR FINAL APPROVAL PRIOR TO PROCEEDING WITH WORK.
- PENDING REPORT LA TO PROVIDE RECOMMENDATIONS TO CLIENT FOR LOW-MAINTENANCE PLANT MATERIAL FOR INDICATED LOCATIONS.
- ROOTBALLS TO BE REMOVED WITH REMOVAL OF SHRUBS & PERENNIALS.

TREE REMOVAL SCHEDULE

TREES				
KEY	CALIPER	TREE SPECIES	COMMON NAME	CONDITION
1	3"	UNKNOWN	UNKNOWN	
2	3"	BETULA NIGRA	RIVER BIRCH	
3	3"	UNKNOWN	UNKNOWN	
4	6"	AILANTHUS ALTISSIMA	TREE OF HEAVEN	
5	8"	AILANTHUS ALTISSIMA	TREE OF HEAVEN	
6	16"	AILANTHUS ALTISSIMA	TREE OF HEAVEN	
7	12"	AILANTHUS ALTISSIMA	TREE OF HEAVEN	
8	8"	AILANTHUS ALTISSIMA	TREE OF HEAVEN	
9	12"	AILANTHUS ALTISSIMA	TREE OF HEAVEN	
10	8"	AILANTHUS ALTISSIMA	TREE OF HEAVEN	
11	TBD	AILANTHUS ALTISSIMA	TREE OF HEAVEN	
12	12"	UNKNOWN	UNKNOWN	
13	16"	UNKNOWN	UNKNOWN	
14	12"	AILANTHUS ALTISSIMA	TREE OF HEAVEN	
15	14"	AILANTHUS ALTISSIMA	TREE OF HEAVEN	
16	8"	AILANTHUS ALTISSIMA	TREE OF HEAVEN	
17	6"	MALUS SPP	CRABAPPLE	

\*TREE GRADES AND SPECIES CONFIRMATION PENDING ARBORIST REPORT

74 Middlesex

74 Middlesex Ave  
Somerville, MA 02145

Client  
GreyStar  
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Landscape Architect  
Mikyoung Kim Design  
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LEED / Environmental Consultant  
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Building Envelope Consultant  
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Lighting Consultant  
Lam Partners  
84 Sherman Street  
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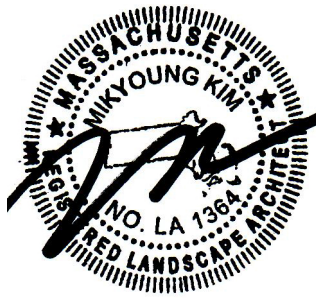
Wind Analysis  
RWGI  
85 Broad Street, 16th Floor  
New York / NY / 10004

Specifications  
Kalin Associates  
1121 Washington Street #2  
West Newton / MA / 02455

Facade Maintenance  
Entek Engineering  
166 Ames Street  
Hockensack / NJ / 07801

Signage  
Roll Barresi & Associates  
48 Dunster Street  
Cambridge / MA / 02138

SITE PLAN APPROVAL



PROJECT NUMBER:

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SCALE: 1/16"=1'-0"

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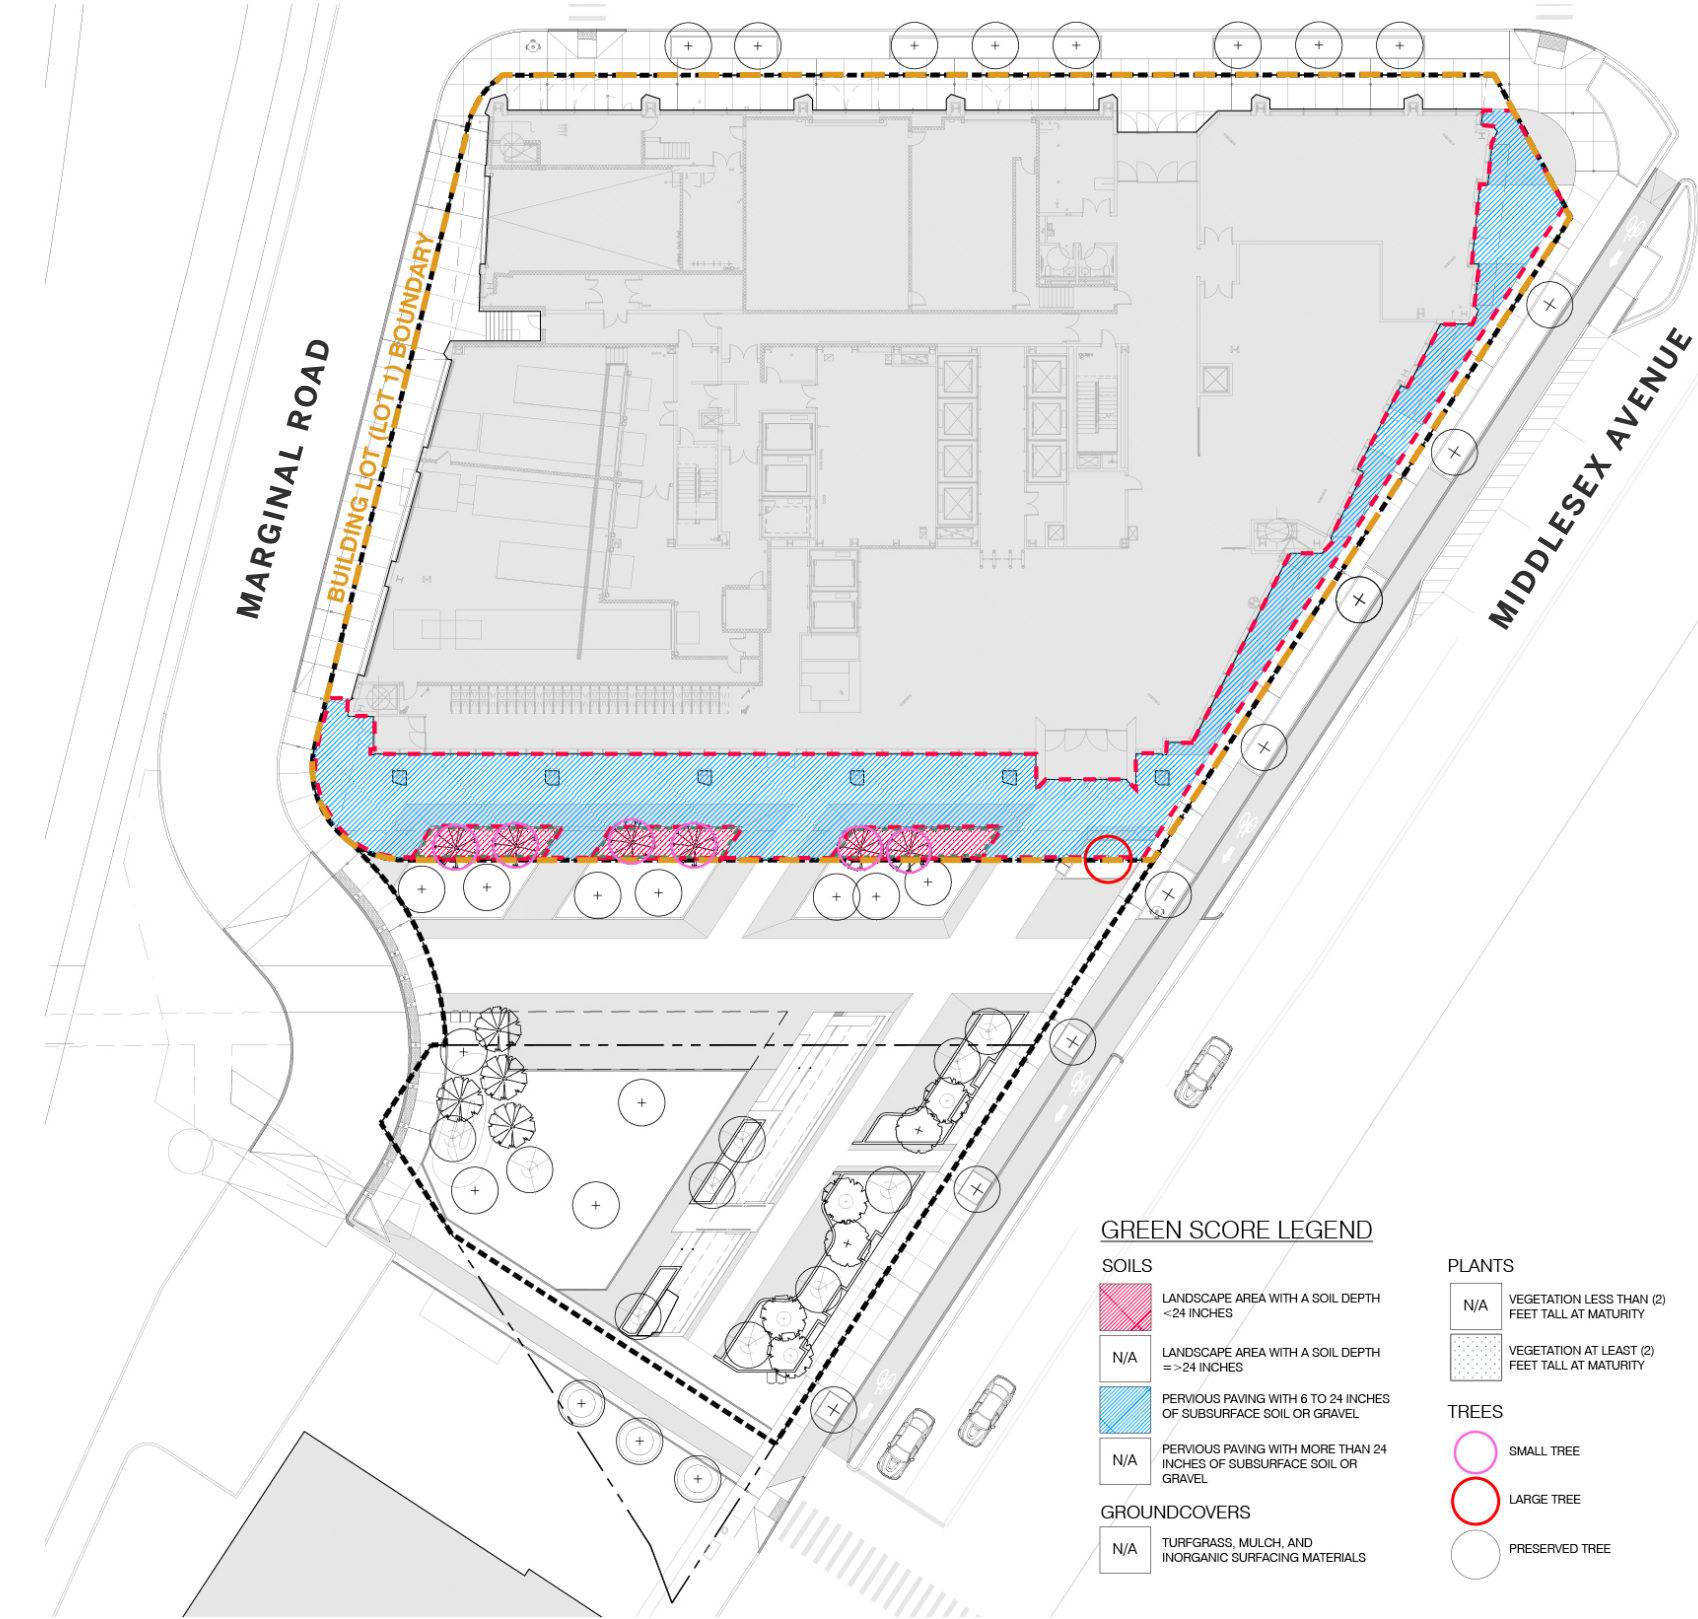
EXISTING TREE PLAN

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NOT FOR CONSTRUCTION





Source: Mikyoung Kim Design


Somerville Green Score							
<b>DIRECTIONS:</b>		Area or Number					
1. Enter the Lot Area in square feet to the right >>>		36,932					
2. Enter the area in square feet or the number of landscape elements							
			Sq Ft Credit	Multiplier	Weighted Area	Score Value	% of Score
<b>Soils</b>							
Landscaped area with a soil depth less than 24 inches (enter square feet)		655	actual sq ft	0.3	196.5	0.005	3%
Landscaped area with a soil depth equal to or greater than 24 inches (enter square feet)			actual sq ft	0.6	0	0.000	0%
<b>Bonus score:</b> Publicly Visible Landscape		655	actual sq ft	0.1	65.5	0.002	1%
Pervious Paving with 6 to 24 inches of subsurface soil or gravel (enter square feet)		4,570	actual sq ft	0.2	914	0.025	12%
Pervious Paving with more than 24 inches of subsurface soil or gravel (enter square feet)			actual sq ft	0.5	0	0.000	0%
<b>Bonus score:</b> Publicly Visible Landscape		4,570	actual sq ft	0.1	457	0.012	6%
<b>Groundcovers</b>							
Turf grass, mulch, and inorganic surfacing materials (enter square feet)			actual sq ft	0.1	0	0.000	0%
<b>Plants</b>							
Vegetation less than two (2) feet tall at maturity (enter square feet)		655	actual sq ft	0.2	131	0.004	2%
<b>Bonus score:</b> Publicly Visible Landscape		655	actual sq ft	0.1	65.5	0.002	1%
<b>Bonus score:</b> Native Species		655	actual sq ft	0.1	65.5	0.002	1%
Vegetation at least two (2) feet tall at maturity (enter number of individual plants)		22	12	0.3	79.2	0.002	1%
<b>Bonus score:</b> Publicly Visible Landscape		22	12	0.1	26.4	0.001	0%
<b>Bonus score:</b> Native Species		22	12	0.1	26.4	0.001	0%
<b>Trees</b>							
Small Tree (enter number of trees)		5	50	0.6	150	0.004	2%
<b>Bonus score:</b> Publicly Visible Landscape		5	50	0.1	25	0.001	0%
<b>Bonus score:</b> Native Species		5	50	0.1	25	0.001	
<b>Bonus score:</b> High Value Species		5	50	0.1	25	0.001	0%
Large Tree (enter number of trees)		1	450	0.6	270	0.007	4%
<b>Bonus score:</b> Publicly Visible Landscape		1	450	0.1	45	0.001	1%
<b>Bonus score:</b> High Value Species		1	450	0.1	45	0.001	1%
Preserved Tree (enter DBH)			65	0.8	0	0.000	0%
<b>Engineered Landscape</b>							
Vegetated Wall (enter square feet)			actual sq ft	0.1	0	0.000	0%
Rain gardens, bioswales, and stormwater planters (enter square feet)			actual sq ft	1.0	0	0.000	0%
Green Roof with up to 6" of growth medium (enter square feet)			actual sq ft	0.1	0	0.000	0%
Green Roof with 6"-10" of growth medium (enter square feet)		2,678	actual sq ft	0.4	1071.2	0.029	15%
Green Roof of 10"-24" growth medium (enter square feet)		6,173	actual sq ft	0.6	3703.8	0.100	50%
Green Roof of over 24" growth medium		N/A	Calculate as if soils, groundcovers, plants, and trees				N/A
			Green Score =				0.200
<b>LANDSCAPE</b>		<b>Green Score District Requirements</b>					
<b>BONUS CREDIT</b>							
PUBLICLY VISIBLE LANDSCAPE							

mikyoung kim design

Figure GS.2a  
Green Scorecard

74 Middlesex Avenue  
Somerville, Massachusetts



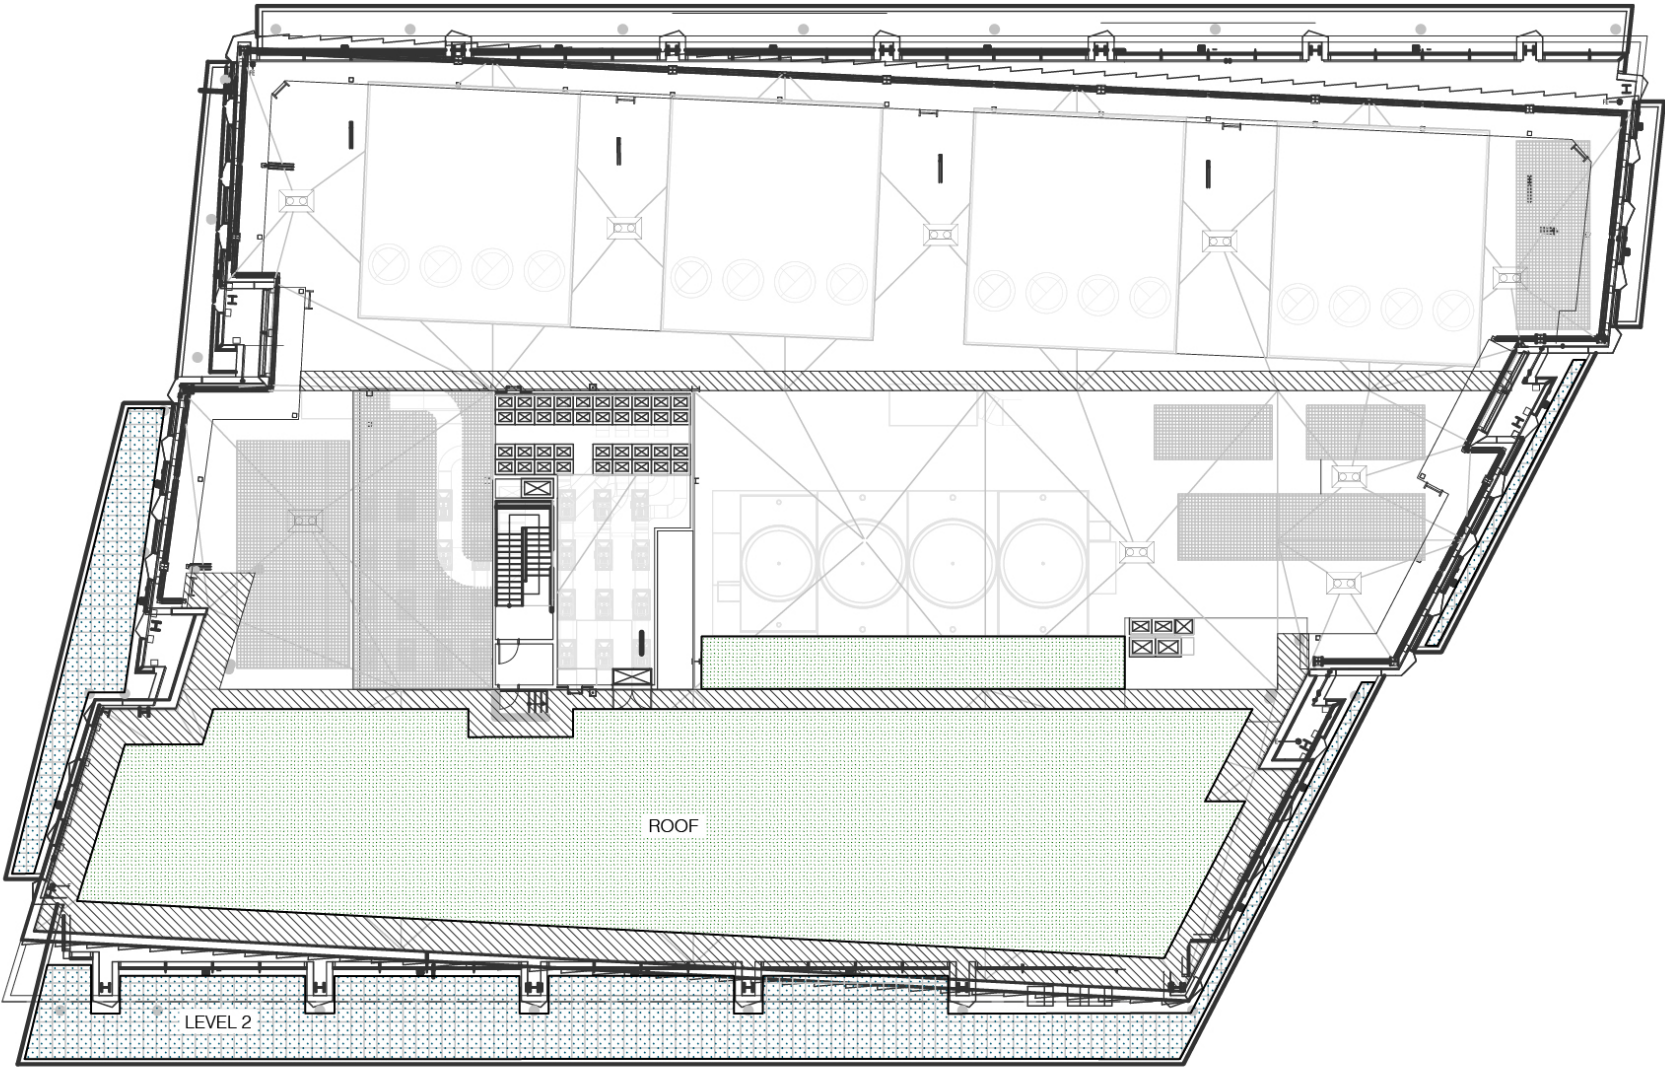

GREEN SCORE LEGEND

SOILS

- LANDSCAPE AREA WITH A SOIL DEPTH <24 INCHES
- LANDSCAPE AREA WITH A SOIL DEPTH ≥24 INCHES
- PERVIOUS PAVING WITH 6 TO 24 INCHES OF SUBSURFACE SOIL OR GRAVEL
- N/A PERVIOUS PAVING WITH MORE THAN 24 INCHES OF SUBSURFACE SOIL OR GRAVEL

GROUNDCOVERS

- N/A TURFGRASS, MULCH, AND INORGANIC SURFACING MATERIALS

PLANTS

- VEGETATION LESS THAN (2) FEET TALL AT MATURITY
- VEGETATION AT LEAST (2) FEET TALL AT MATURITY

TREES

- SMALL TREE
- LARGE TREE
- PRESERVED TREE

ENGINEERED LANDSCAPE

- N/A VEGETATED WALL
- N/A RAIN GARDEN, BIOSWALE, AND STORMWATER PLANTERS
- N/A GREEN ROOF WITH UP TO 6" OF GROWTH MEDIUM
- GREEN ROOF WITH 6"-10" OF GROWTH MEDIUM
- GREEN ROOF WITH 10"-24" OF GROWTH MEDIUM
- N/A GREEN ROOF WITH OVER 24" OF GROWTH MEDIUM

BONUS CREDIT

- PUBLICLY VISIBLE LANDSCAPE
- N/A NATIVE SPECIES (100% NATIVE PROPOSED)
- N/A HIGH VALUE SPECIES
- N/A 50% OF IRRIGATION IS HARVESTED RAINWATER
- N/A FOOD CULTIVATION
- N/A DE-PAVED LOT AREA

Source: Mikyoung Kim Design

mikyoung kim design

Figure GS.2b  
Green Scorecard

74 Middlesex Avenue  
Somerville, Massachusetts







## 74 Middlesex

74 Middlesex Ave  
Somerville, MA 02145

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### Parking Consultant

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Boston / MA / 02108

### Lighting Consultant

Lam Partners  
84 Sherman Street  
Cambridge / MA / 02140

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New York / NY / 10004

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### Facade Maintenance

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166 Ames Street  
Hackensack / NJ / 07601

### Signage

Roll Barresi & Associates  
48 Dunster Street  
Cambridge / MA / 02138

## SITE PLAN APPROVAL



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SCALE: 1"=10'


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## GRADING PLAN

Ref. North

DRAWING NUMBER:

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### GRADING PLAN LEGEND

---XXX---	EXISTING CONTOUR
XXX	PROPOSED CONTOUR
(XX.XX)	EXISTING SPOT ELEVATION (V.I.F.)
[XX.XX]	PROPOSED SPOT ELEVATION
+HP	HIGH POINT ELEVATION
+LP	LOW POINT ELEVATION
X.XX	RATIO OF DOWN SLOPE (HORIZ:VERT)
0.00	DIRECTION/ PERCENTAGE OF DOWN SLOPE
---	GRADE BREAK
BT	BOTTOM OF TRENCH ELEVATION
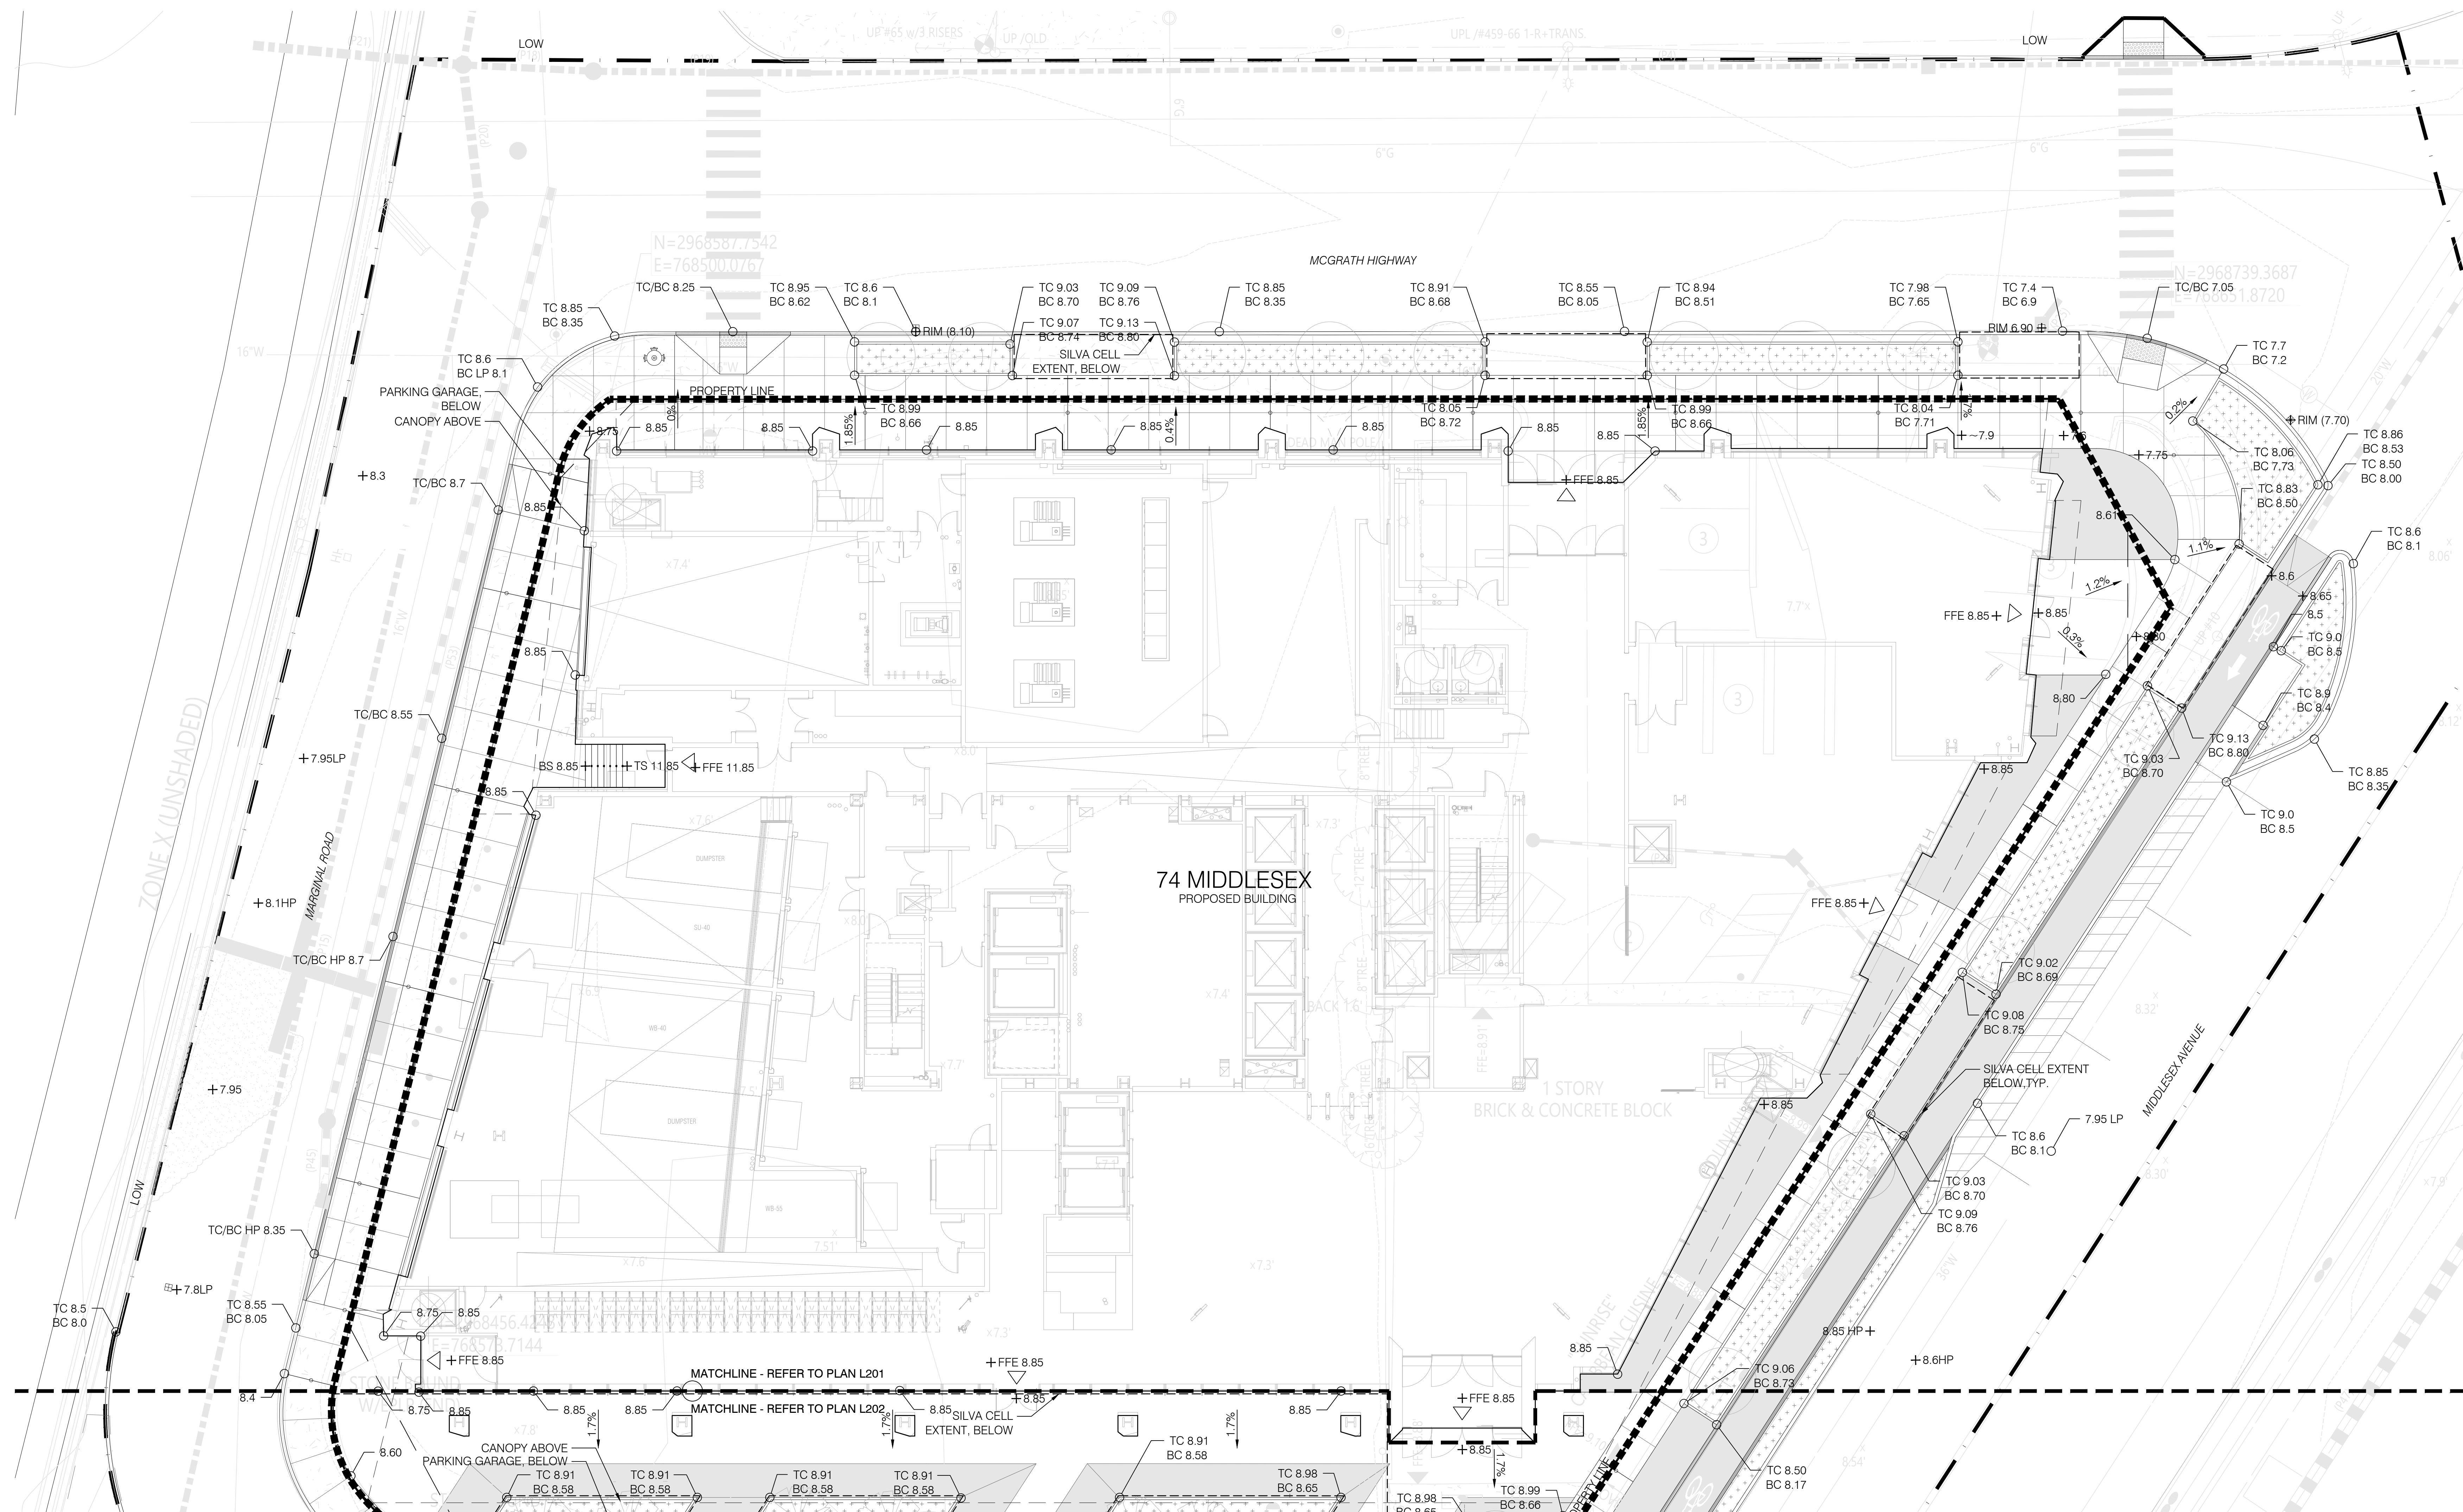
### GRADING PLAN KEY

- EXISTING/ PROPOSED SITE CONDITIONS BY OTHERS  
REFER TO LAYOUT AND MATERIALS PLAN L101-L103
- SURFACES, EDGING, AND CURBS  
REFER TO LAYOUT AND MATERIALS PLAN L101-L103
- SITE ELEMENTS  
REFER TO LAYOUT AND MATERIALS PLAN L101-L103
- SITE FURNISHINGS  
REFER TO LAYOUT AND MATERIALS PLAN L101-L103
- DRAINAGE

(5.1)	DRAIN TYPE 1 - AREA	REFER TO CIVIL
(5.2)	DRAIN TYPE 2 - TRENCH	REFER TO CIVIL
(5.3)	DRAIN TYPE 3 - OVERFLOW	REFER TO CIVIL
(5.4)	DRAIN TYPE 4 - DRAIN TILE	9/L510

### GRADING PLAN NOTES

- REFER TO SHEET L000 FOR GENERAL GRADING NOTES.
- CROSS SLOPES AT ALL PAVED SURFACES SHALL NOT EXCEED 1.8%.
- LONGITUDINAL SLOPES SHALL NOT EXCEED 4.8%.
- REFER TO CIVIL FOR ALL STREET CURB, BIKE LANE AND STREET GRADES. ADVISE ASAP OF ANY DISCREPANCIES.



## 74 Middlesex

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### Lighting Consultant

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Hackensack / NJ / 07601

### Signage

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Cambridge / MA / 02138

### SITE PLAN APPROVAL



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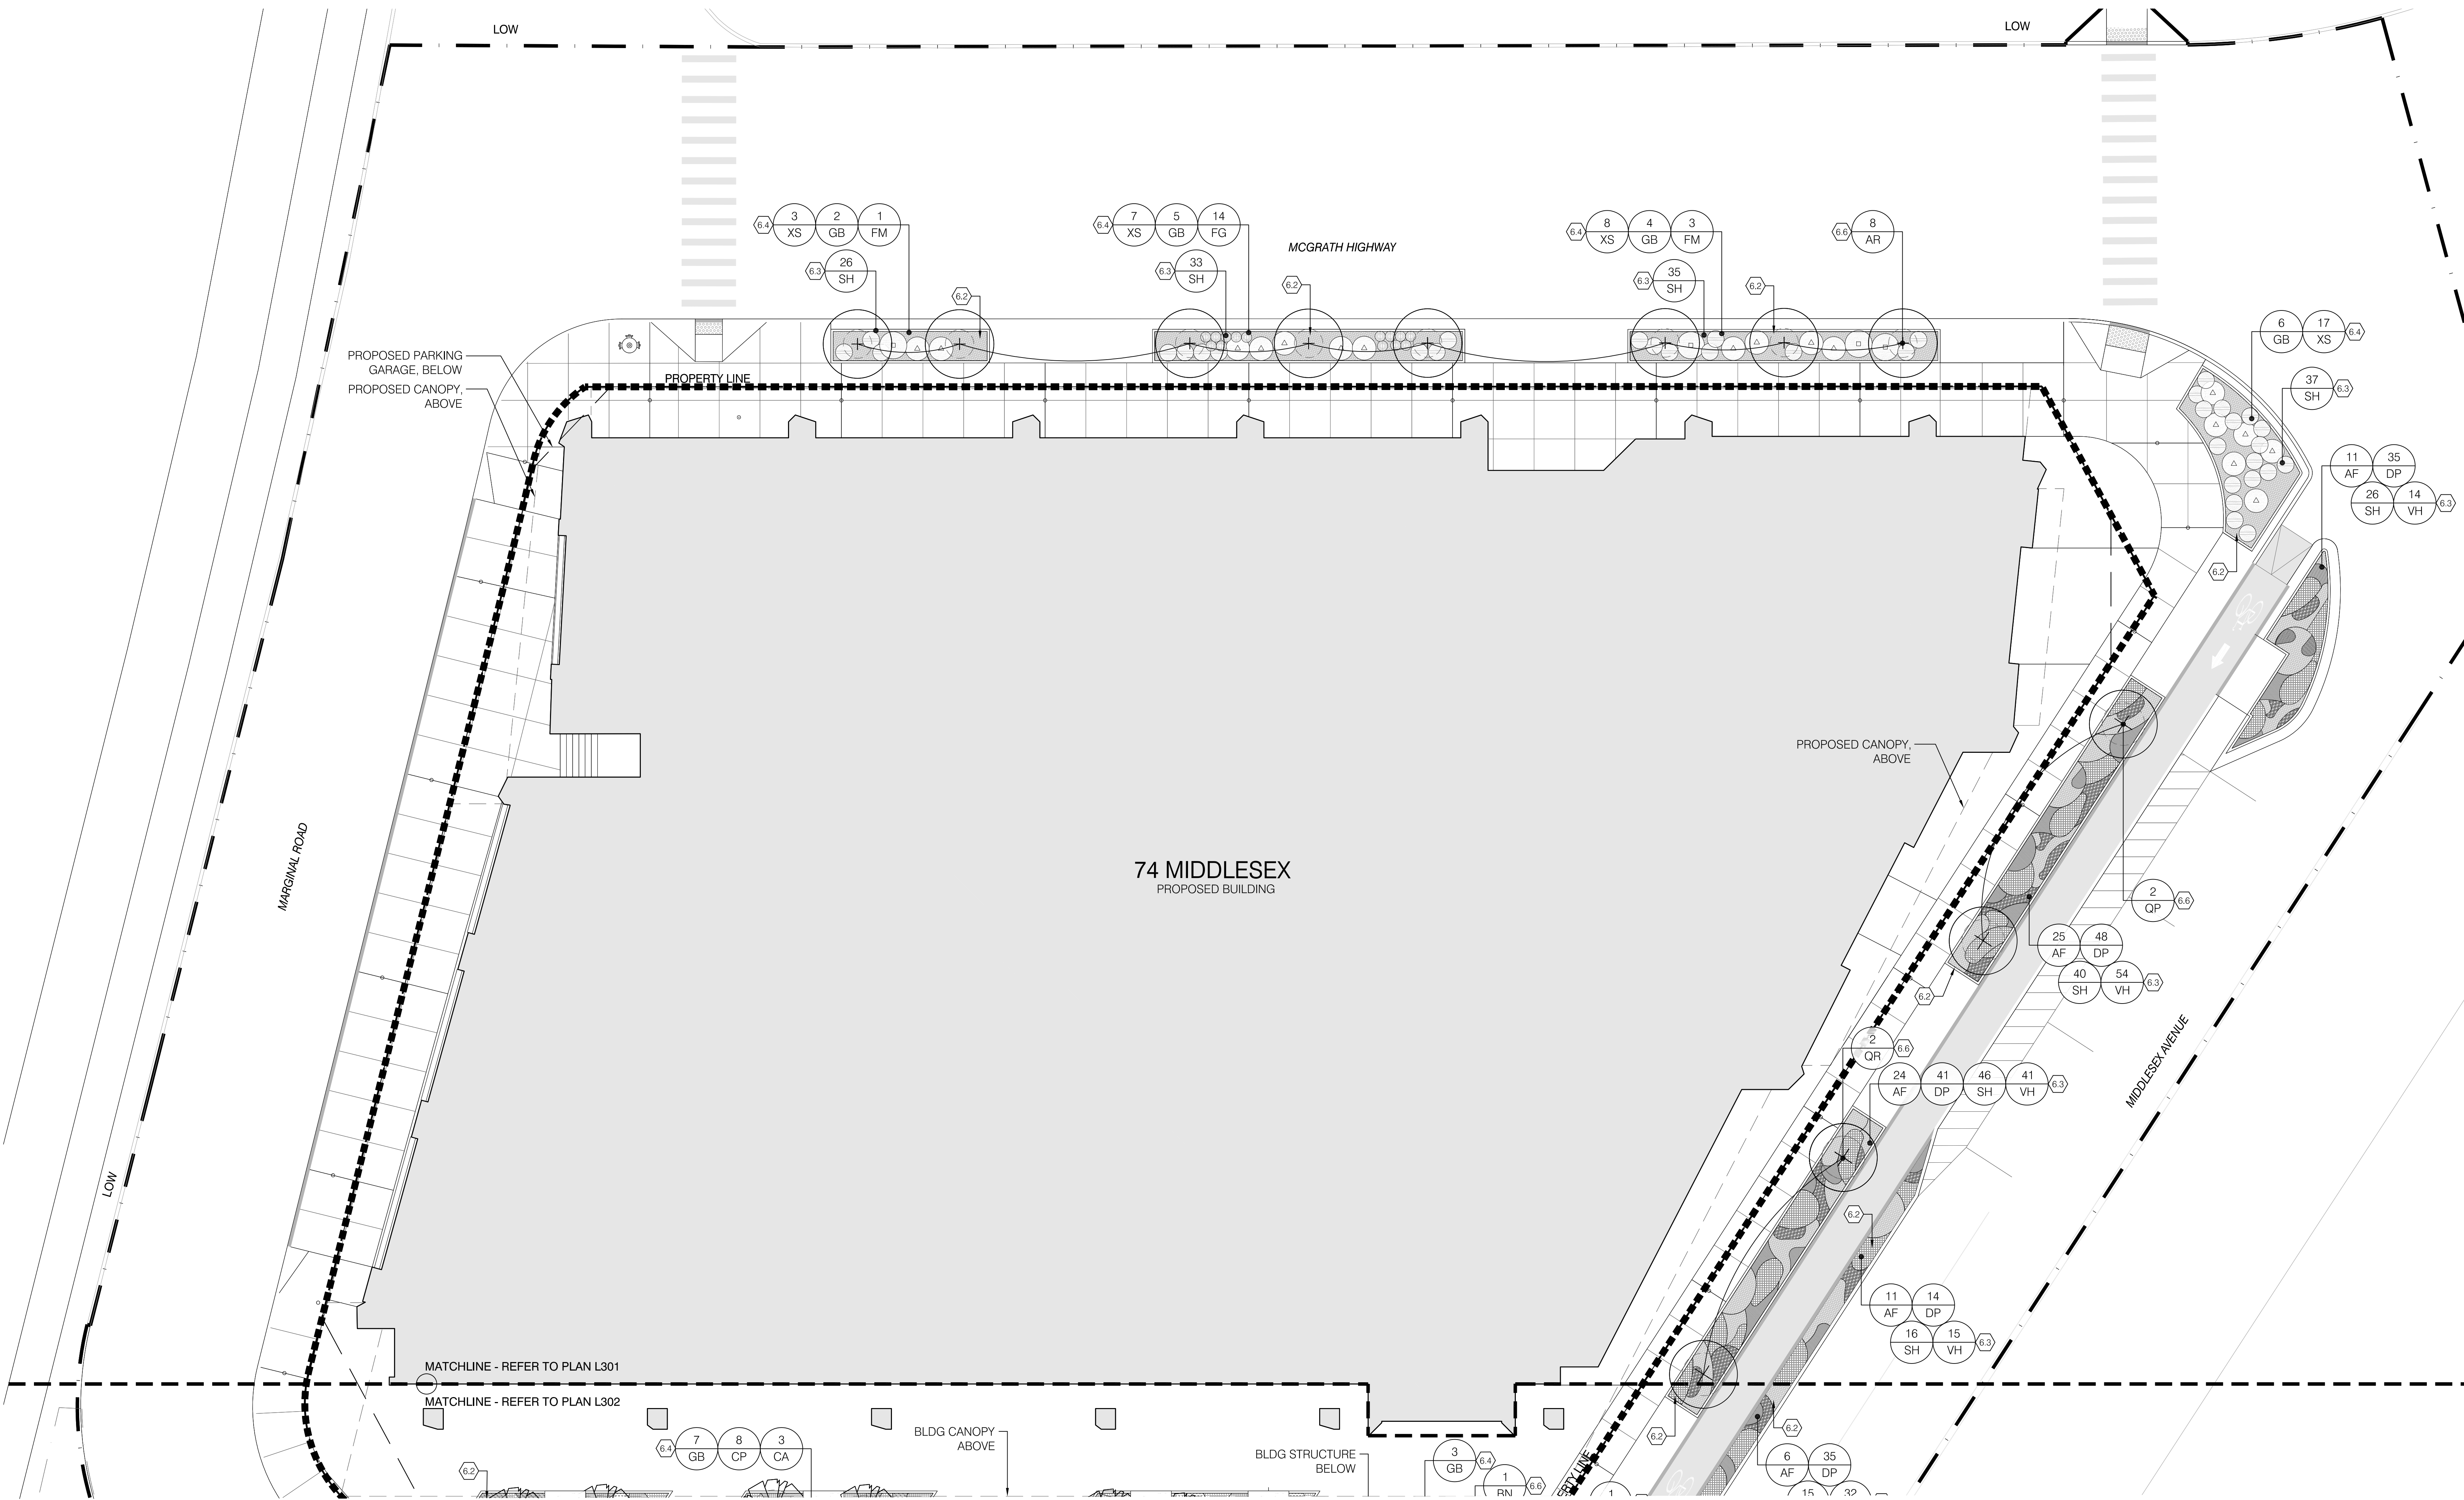
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PLANTING PLAN



DRAWING NUMBER:

# GS.5



PLANTING PLAN KEY		
1.0	EXISTING PROPOSED CONDITIONS	
	REFER TO LAYOUT AND MATERIALS PLAN L101-L103	
2.0	SURFACES, EDGING, AND CURBS	
	REFER TO LAYOUT AND MATERIALS PLAN L101	
3.0	SITE ELEMENTS	
	REFER TO LAYOUT AND MATERIALS PLAN L101-L103	
4.0	SITE FURNISHINGS	
	REFER TO LAYOUT AND MATERIALS PLAN L101-L103	
5.0	DRAINAGE	
	REFER TO GRADING PLANS L201-L203	
6.0	PLANTING	
	6.1 SOIL PROFILE 1 - LAWN	1/L510
	6.2 SOIL PROFILE 2 - PLANT BED	2/L510
	6.3 PERENNIAL PLANTING	5/L510
	6.4 SHRUB PLANTING	6/L510
	6.5 LANDSCAPE EDGING	7/L510
	6.6 TREE TYPE 1 - AT PLANT BED	1/L511
	6.7 TREE TYPE 2 - AT LAWN	2/L511
	6.8 TREE TYPE 3 - STREETScape	3/L511
PLANTING PLAN NOTES		
1. REFER TO SHEET L000 FOR ADDITIONAL PLANTING NOTES.		
2. PLANT QUANTITIES LISTED IN PLANTING SCHEDULE INDICATE COMBINED TOTAL FOR ALL PLANTING AREAS.		
3. REFER TO SPECIFICATIONS FOR SOIL MIX AND SOIL PREPARATION INSTRUCTIONS.		
6. ANY ALTERNATE PLANTS SHALL BE SUBMITTED FOR APPROVAL BY LA.		
7. ALL PLANTING AREAS TO CONTAIN IRRIGATION. REFER TO IRRIGATION DRAWINGS FOR DESIGN AND INSTALLATION.		

PLANT SCHEDULE - AREA 1							
TREES							
KEY	PLANT TYPE	COMMON NAME	QTY	ROOT	SIZE	NOTES	
AR	<i>Acer rubrum</i> 'Bowhall'	RED MAPLE	8	B+B	3" CAL	MULTI-STEM	
QP	<i>Quercus palustris</i>	PIN OAK	2	B+B	3" CAL		
QR	<i>Quercus rubra</i>	RED OAK	2	B+B	3" CAL		
SHRUBS							
CA	<i>Clethra alnifolia</i>	SWEET PEPPERBUSH	6	POT	#7		
FG	<i>Fothergilla gardenii</i>	DWARF FOTHERGILLA	26	POT	2'-0" H		
FM	<i>Fothergilla</i> 'Mount Airy'	FOTHERGILLA	13	POT	2'-0" H		
GB	<i>Gaylussacia baccata</i>	BLACK HUCKLEBERRY	17	POT	#7		
XS	<i>Xanthorhiza simplicissima</i>	YELLOWROOT	63	POT	#5		

PERENNIALS/ GROUND COVER							
KEY	PLANT TYPE	COMMON NAME	QTY	ROOT	SIZE	NOTES	
AF	<i>Agastache</i> 'Black Adder'	ANISE HYSSOP	71	POT	#1	PLANT 18" OC	
CS	50% <i>Carex appalachica</i> 50% <i>Carex pennsylvanica</i>	SEDGE SPP	72	POT	#1	PLANT 10" OC	
DP	<i>Dalea purpurea</i>	PURPLE PRAIRIE CLOVER	138	POT	#1	PLANT 12" OC	
EL	<i>Erigeron pulchellus</i> 'Lynnhaven Carpet'	ROBIN'S PLANTAIN	166	POT	#1	PLANT 10" OC	
SH	50% <i>Sporobolus heterolepis</i> 25% <i>Descampsia flexuosa</i> 25% <i>Descampsia cespitosa</i>	NATIVE GRASS SPP	365	POT	#1	PLANT 18" OC	
VH	<i>Verbena hastata</i> f. <i>rosea</i> 'Pink Spires'	VERBENA	124	POT	#1	PLANT 12" OC	








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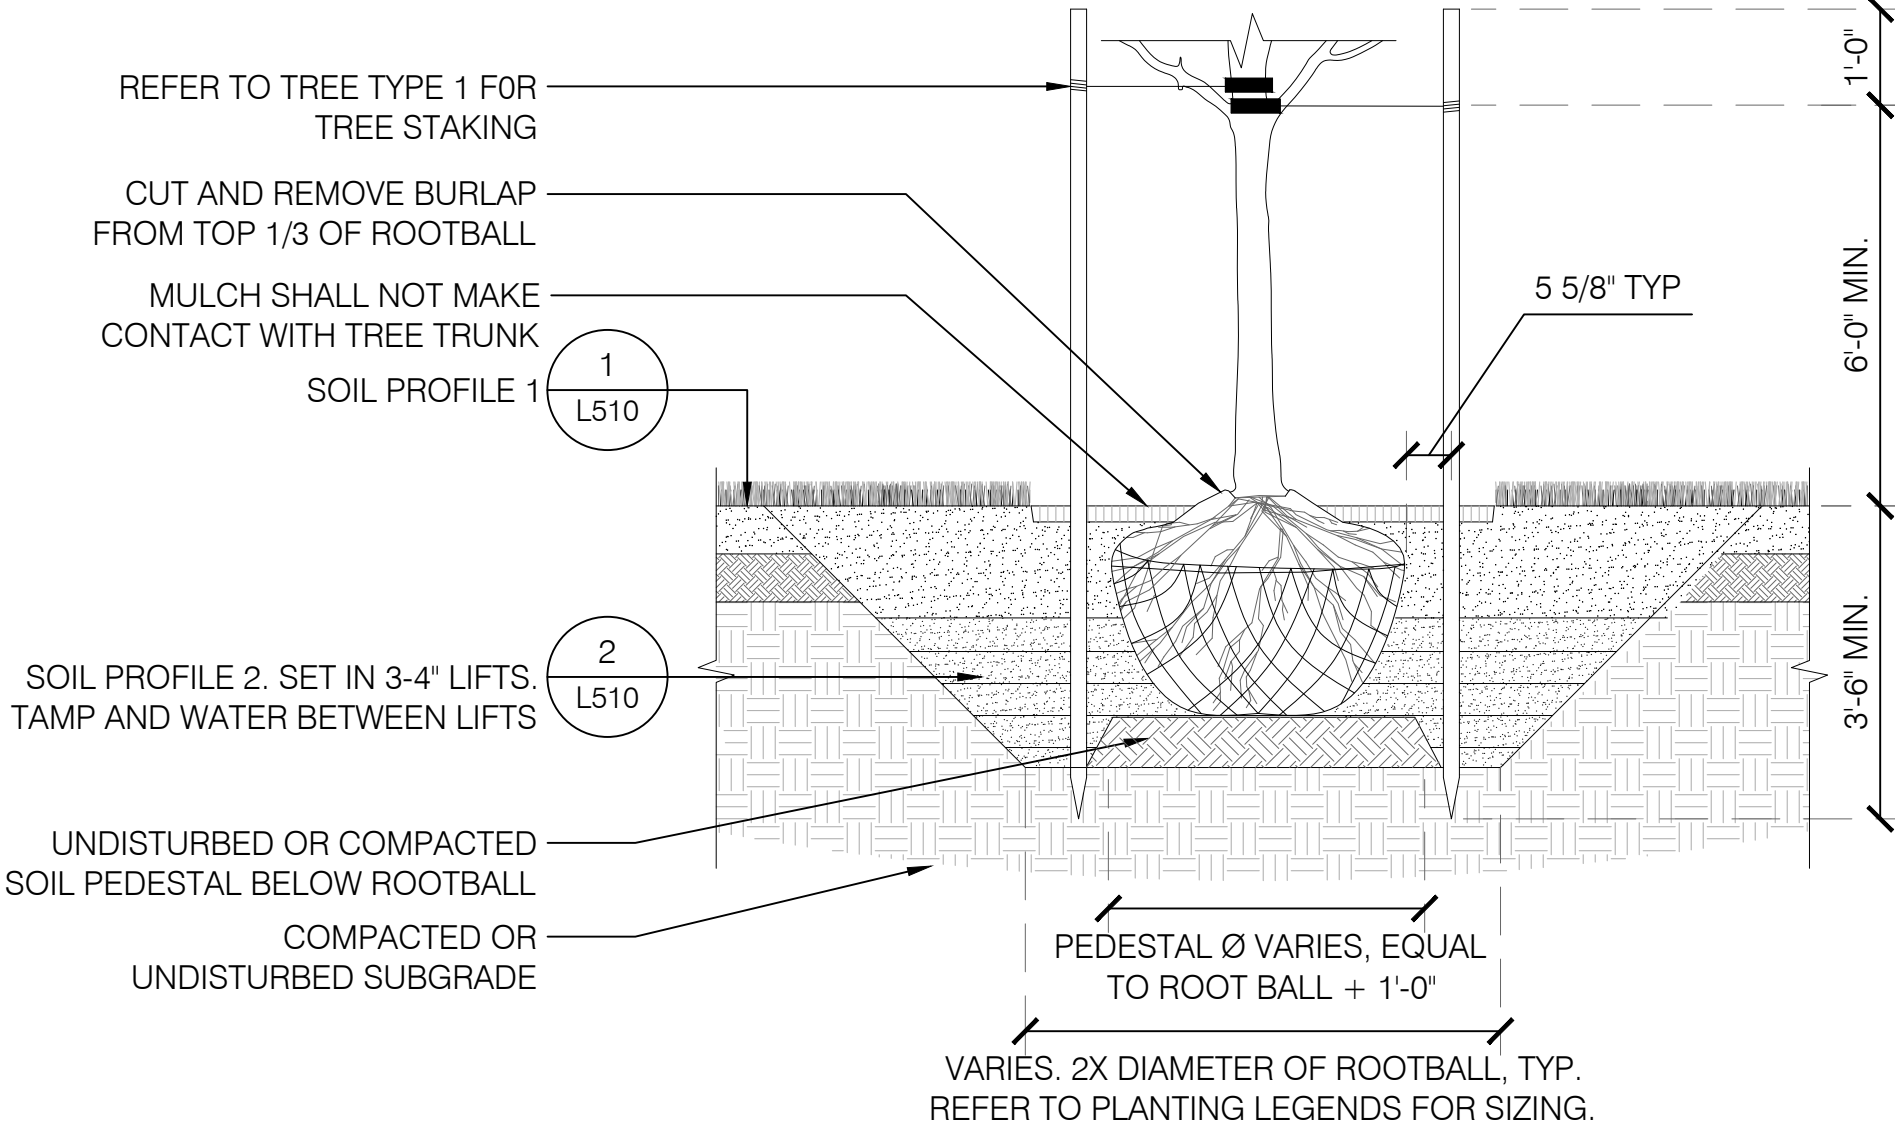
1. PEDESTAL HEIGHT SHALL ACCOMMODATE ROOT BALL SET 4' BELOW FINISH GRADE. REFER TO PLANTING SCHEDULE FOR TREE SIZING.

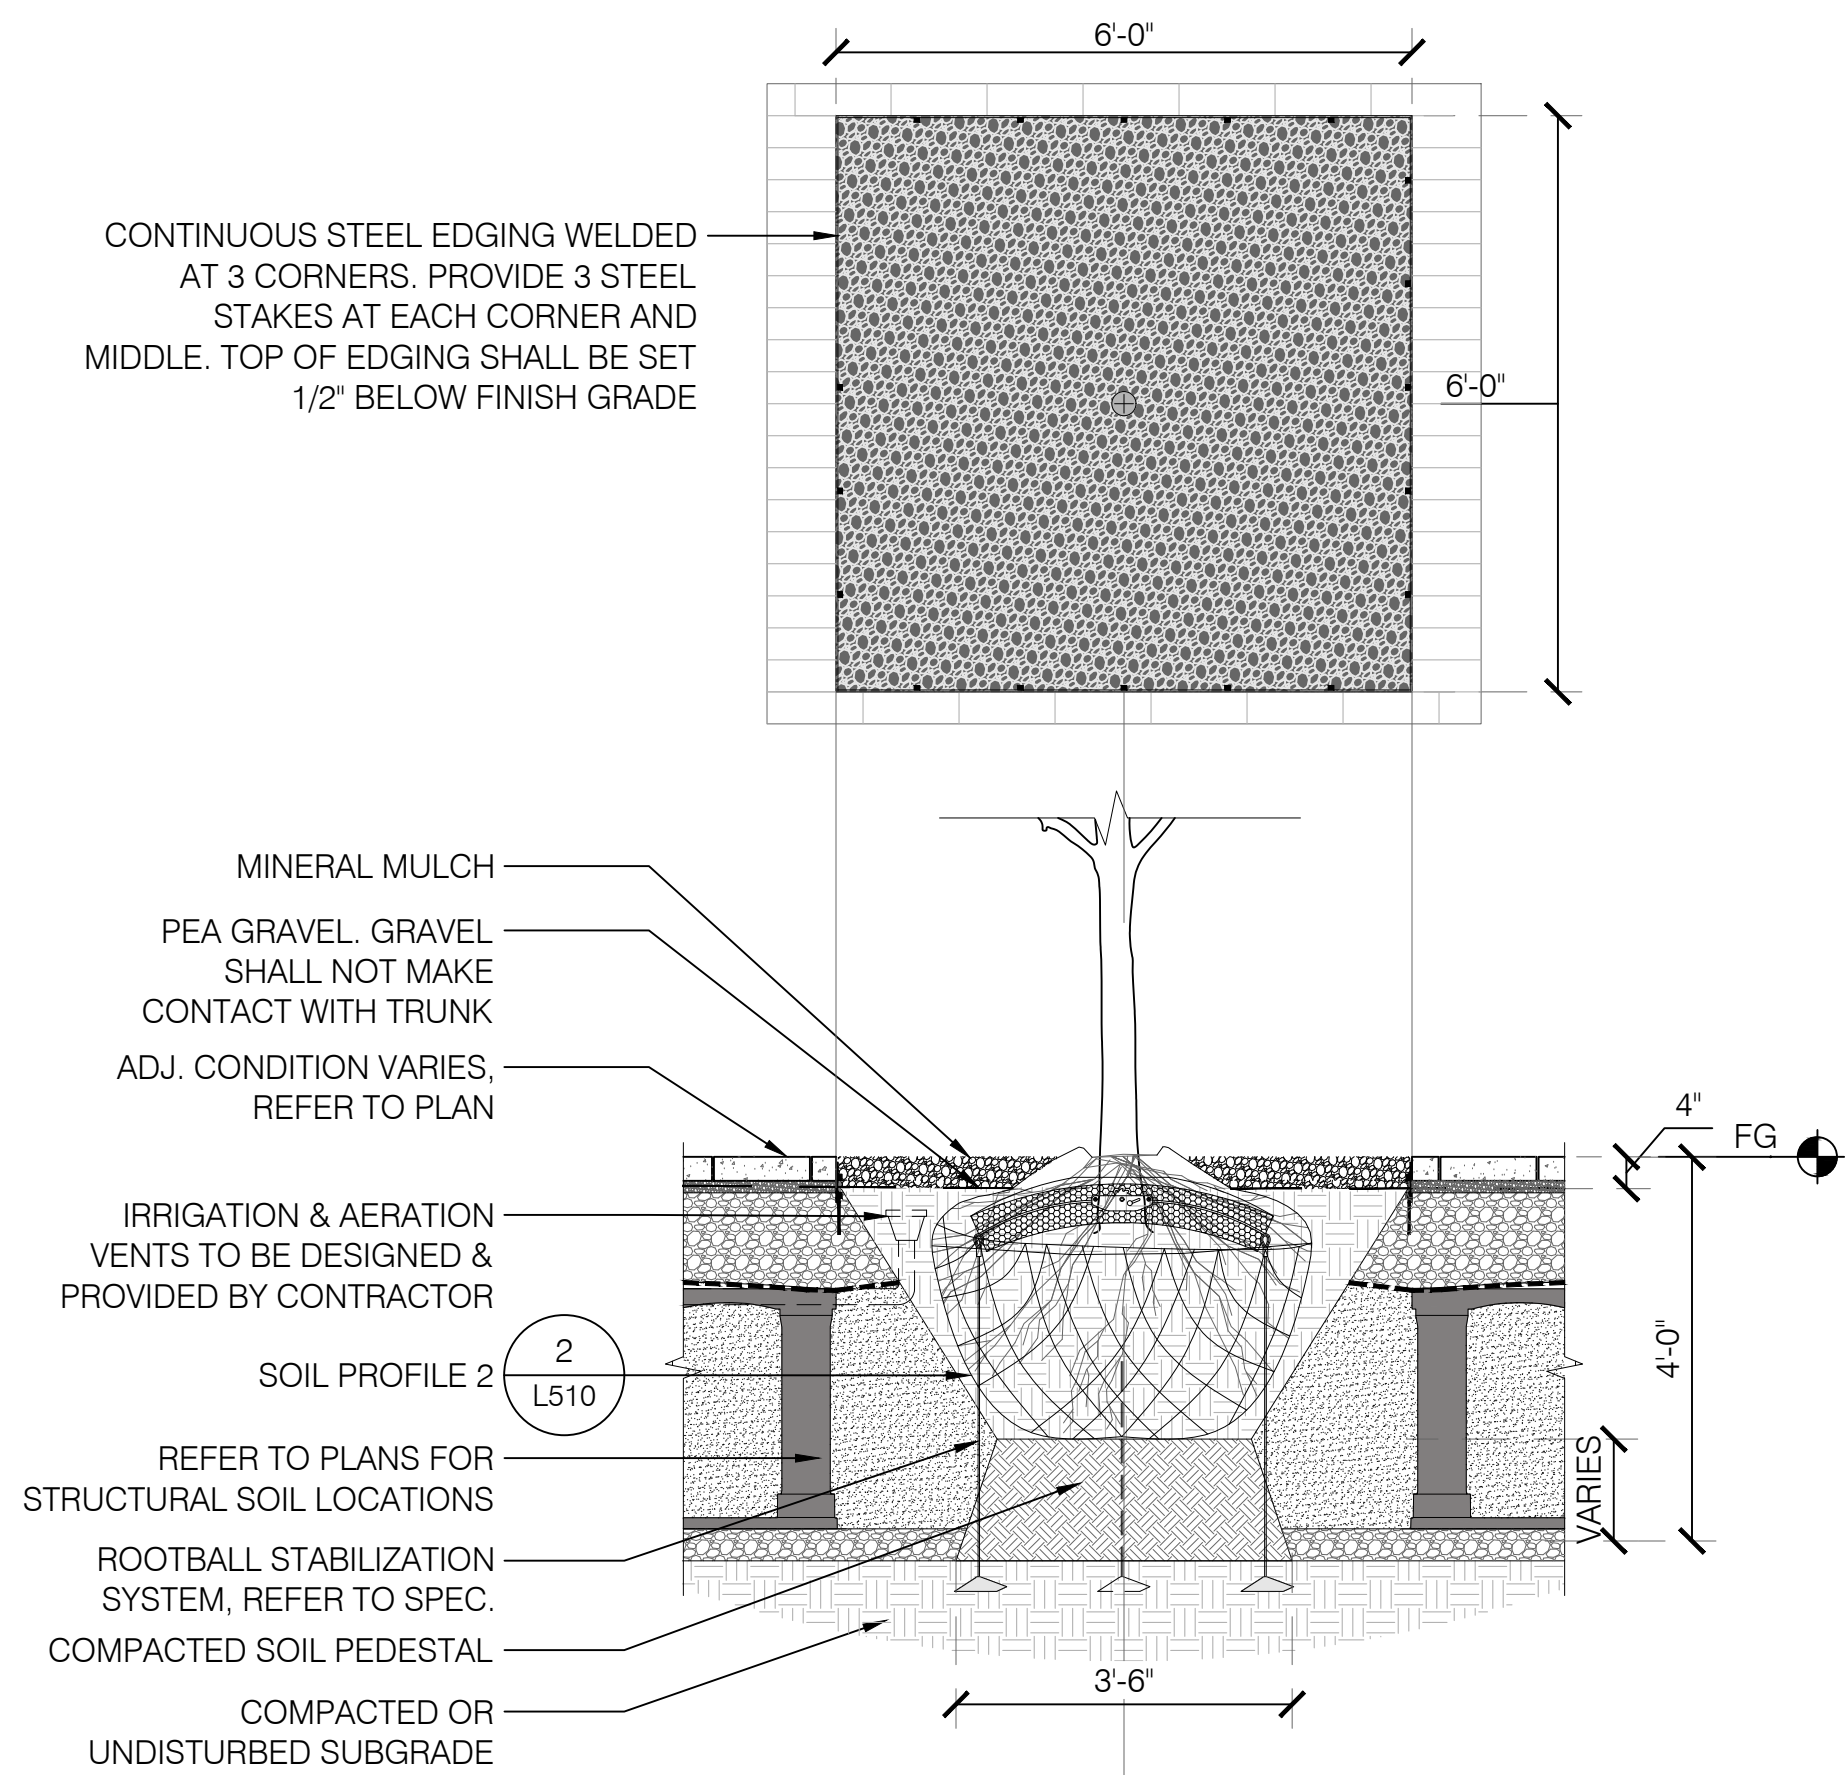

SECTION

NOTE :

1. PEDESTAL HEIGHT SHALL ACCOMMODATE ROOT BALL SET FLUSH TO FINISH GRADE. REFER TO PLANTING SCHEDULE FOR TREE SIZING.




SECTION

NOTE :

1. ORIENT TREE TO HAVE SIMILAR SOLAR ASPECT AS NURSERY OR AS DIRECTED BY LANDSCAPE ARCHITECT. TAGS ARE TO BE PLACED ON THE NORTH SIDE AT NURSERY.
2. DO NOT PRUNE OR THIN CANOPY UNLESS DIRECTED TO DO SO BY LA.
3. CONTRACTOR SHALL REMOVE EXCESS FILL FROM TOP OF TRUNK. SET ROOT FLARE 2" HIGHER THAN FINISHED GRADE. REMOVE ROPE FROM CROWN TO PREVENT GIRDLING.
4. PRIOR TO STAKING, REVIEW EXTENT OF LIMBING UP WITH LA.
5. TREE STAKING MAY BE OMITTED IF ROOTBALL AND CANOPY PROVIDE A STABLE GROWING CONDITION. CONDITION TO BE REVIEWED BY LA AND CONTRACTOR.
6. MOUNDING AROUND TREES WILL NOT BE ACCEPTABLE.
7. REFER TO LAYOUT AND MATERIALS PLAN FOR SPECIFIC TREE STAKING ORIENTATION.
8. PEDESTAL HEIGHT SHALL ACCOMMODATE ROOT BALL SET FLUSH TO FINISH GRADE. REFER TO PLANTING SCHEDULE FOR TREE SIZING.

TREE STAKING PLAN

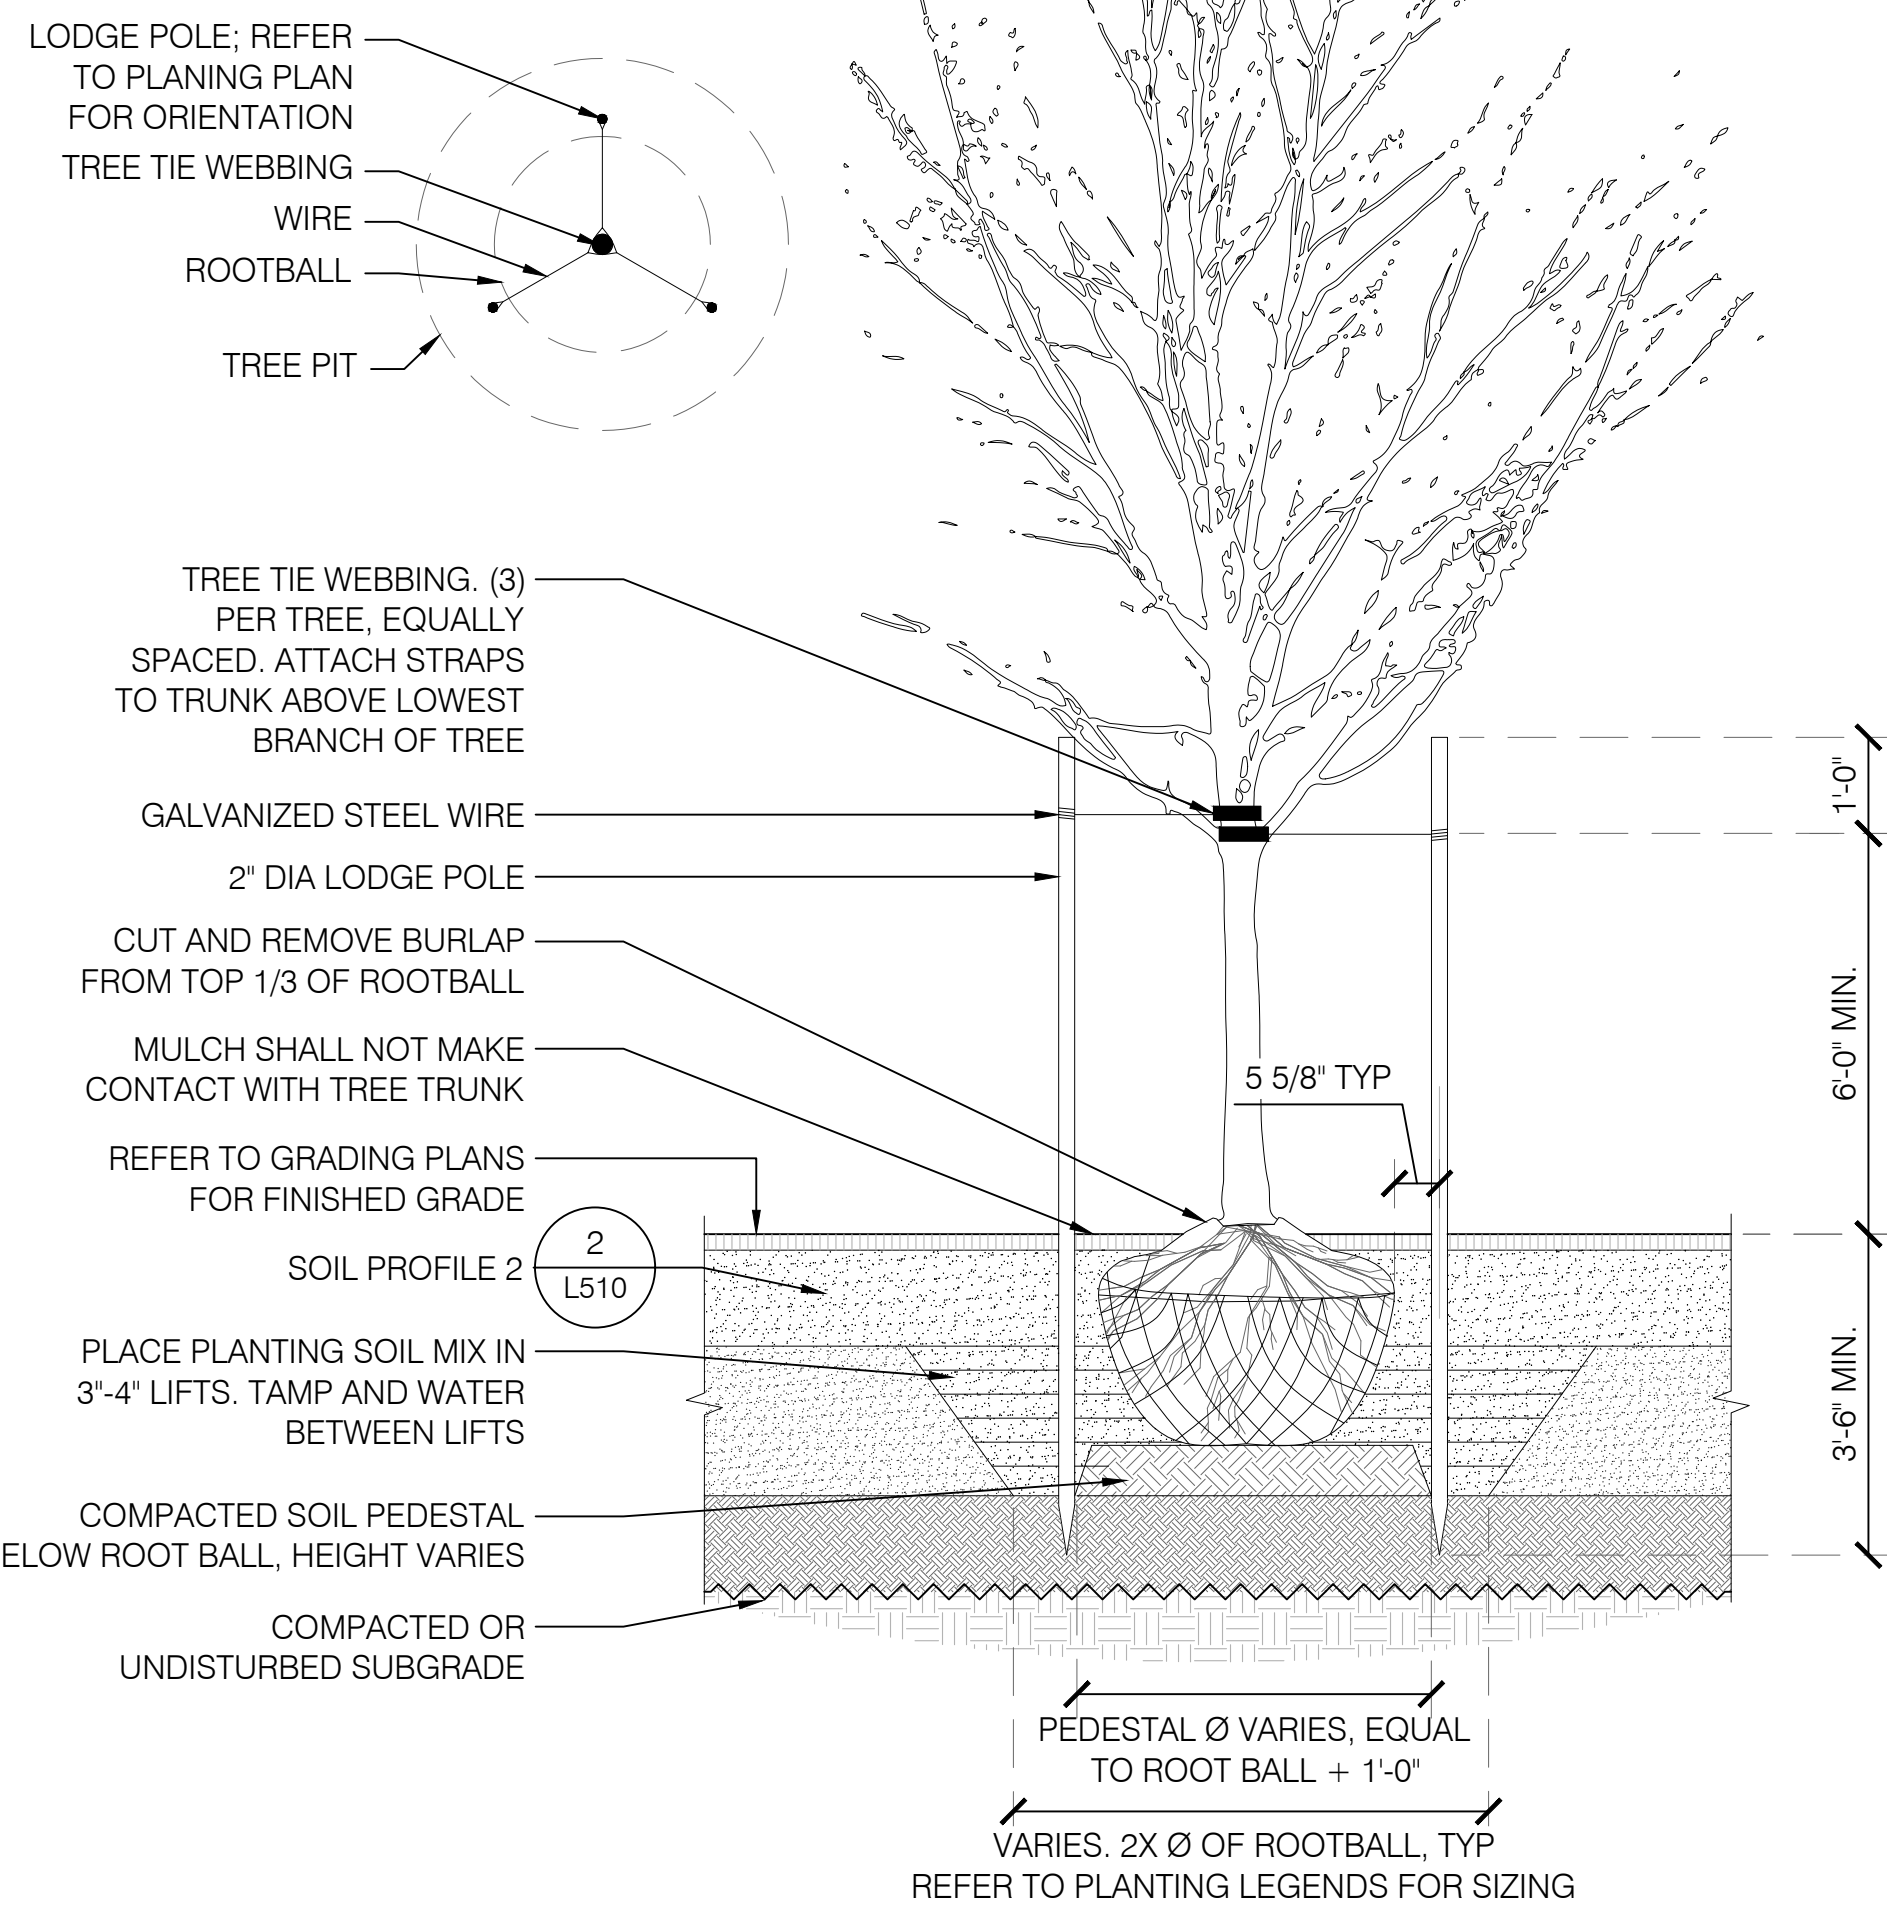

SECTION

## 74 Middlesex

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**Elevator Consultant**

VDA  
101 Summer Street, 4th Floor  
Boston / MA / 02110

**Parking Consultant**

DESMAN, Inc.  
18 Tremont Street #300  
Boston / MA / 02108

**Lighting Consultant**

Lam Partners  
84 Sherman Street  
Cambridge / MA / 02140

**Wind Analysis**

RWDI  
85 Broad Street, 16th Floor  
New York / NY / 10004

**Specifications**

Kalvin Associates  
1121 Washington Street #2  
West Newton / MA / 02459


**Facade Maintenance**

Entek Engineering  
166 Ames Street  
Hackensack / NJ / 07601

**Signage**

Roll Barresi & Associates  
48 Dunster Street  
Cambridge / MA / 02138

### SITE PLAN APPROVAL

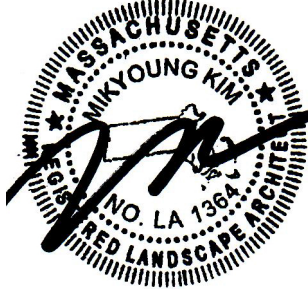

PROJECT NUMBER:

DATE:

REVISIONS:

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SEE PREVIOUS ISSUES FOR REVISIONS NOT LISTED HERE

SCALE: AS NOTED

DRAWING NAME:

### PLANTING DETAILS

DRAWING NUMBER:

# GS.7

NOT FOR CONSTRUCTION



SITE PLAN APPROVAL



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SCALE: AS NOTED

DRAWING NAME:


PAVING AND CURBING  
DETAILS

DRAWING NUMBER:

GS.8

NOTE :


1. REFER TO SPECIFICATION FOR WOOD SPECIES AND FINISH.
2. ALL CONNECTIONS AT INTERFACE WITH WOOD MATERIAL TO BE FASTENED WITH STAINLESS STEEL HARDWARE.
3. ALL FASTENERS TO BE HIDDEN FROM FINISH SURFACE.

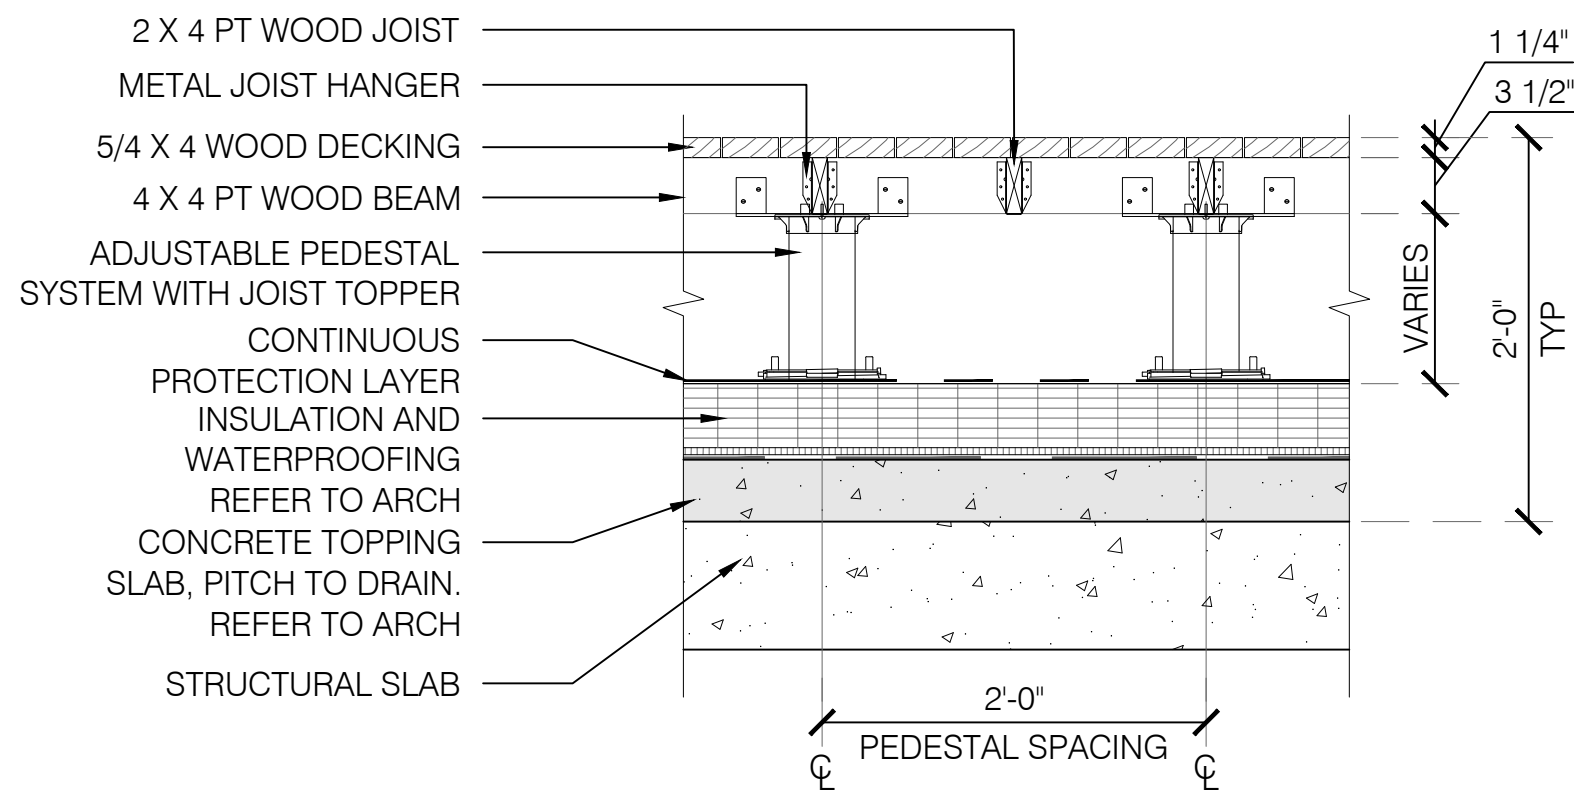


8 DECK TYPE 2 - AT TERRACE  
1" = 1'-0"

NOTES :

1. REFER TO LAYOUT PLAN FOR EXTENT OF DETECTABLE WARNING PAVER AT DROP-OFF. PROVIDE 2'-0" WIDE CUSTOM RADIAL PAVERS TO MATCH CURB LAYOUT AND RADII. ALL RADIAL PAVERS SHALL MAINTAIN TYPICAL TRUNCATED DOME SPACING.

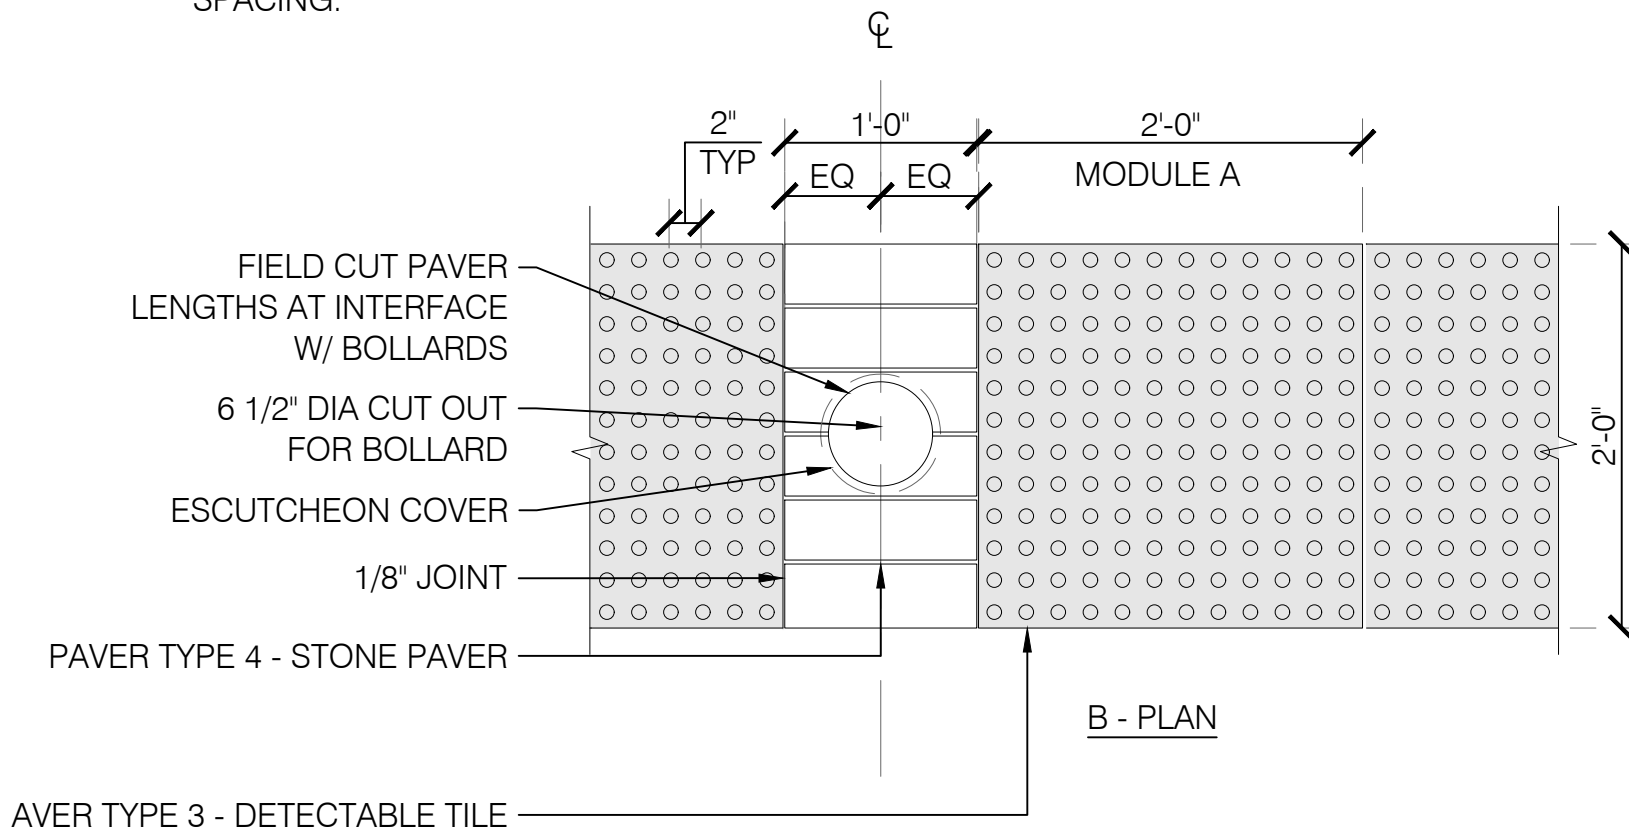


PAVER TYPE 3 - DETECTABLE TILE

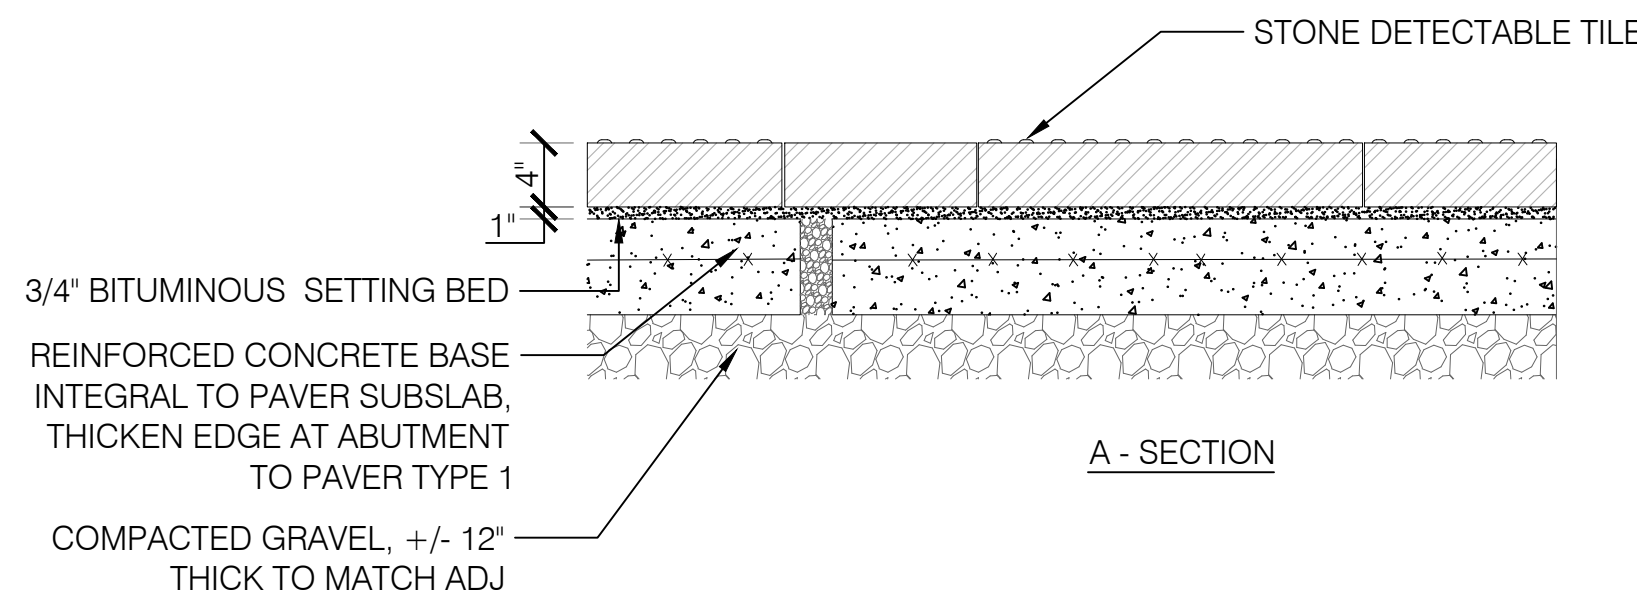

6 PAVER TYPE 3 & 4 - DETECTABLE TILE AND STONE PAVER  
1" = 1'-0"

NOTE :


1. REFER TO SPECIFICATIONS FOR CONCRETE CURING METHOD, COLOR, AND FINISH.
2. REFER TO LAYOUT AND MATERIALS PLANS FOR STRUCTURAL SOIL LOCATIONS.

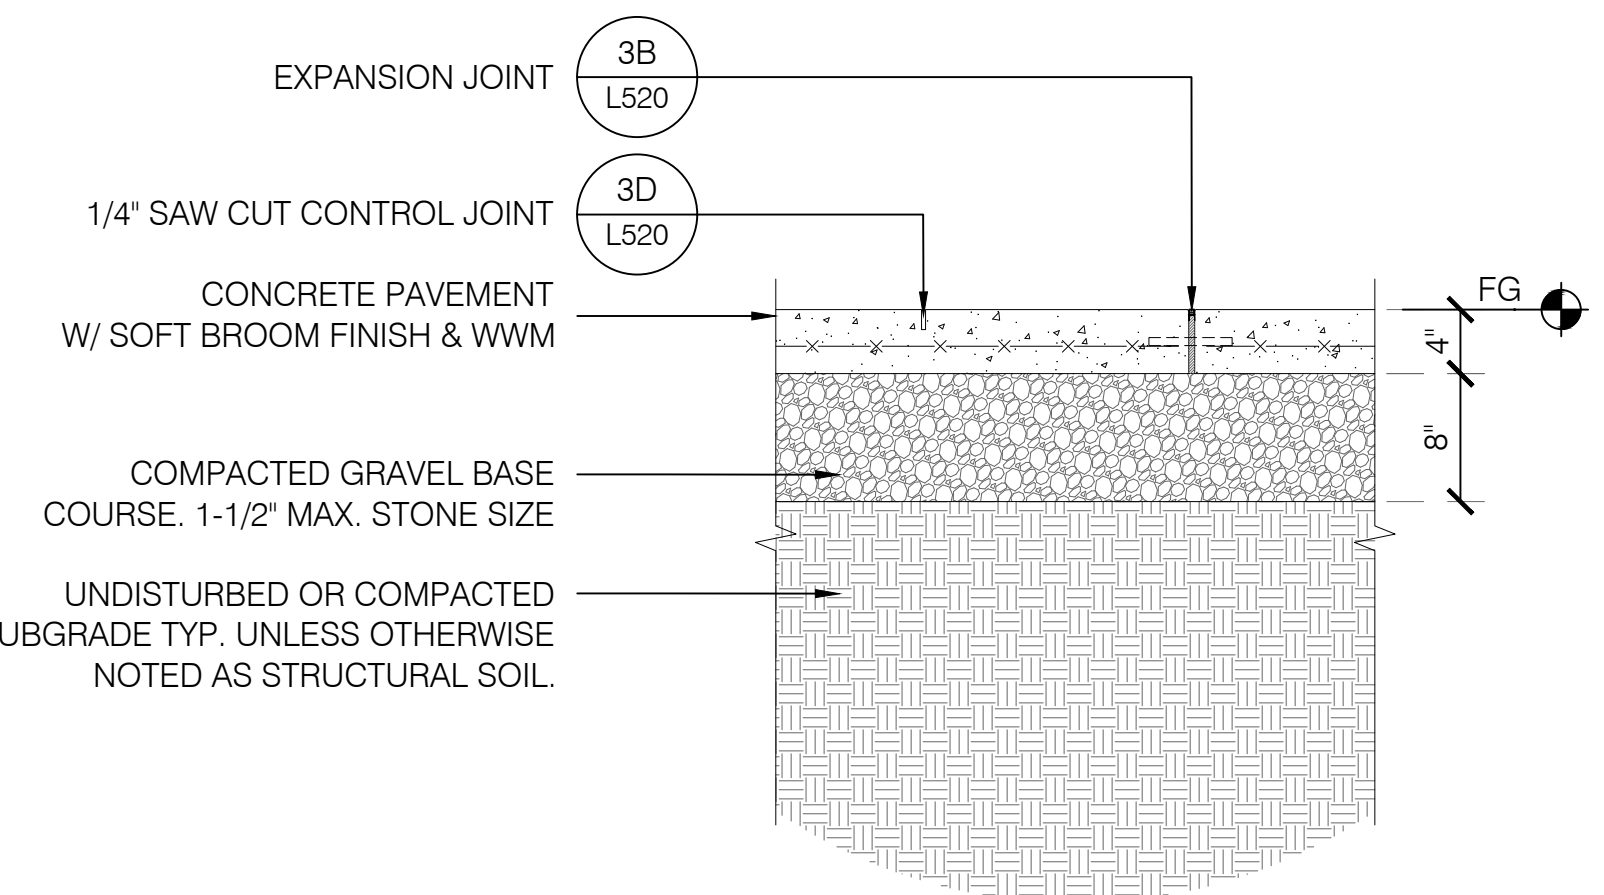

2 PAVING TYPE 2 - STANDARD SIDEWALK  
1" = 1'-0"

NOTE :


1. REFER TO LAYOUT PLAN AND SPEC FOR SPECIFIED PAVER LAYOUT.
2. REFER TO GRADING PLANS FOR FG.

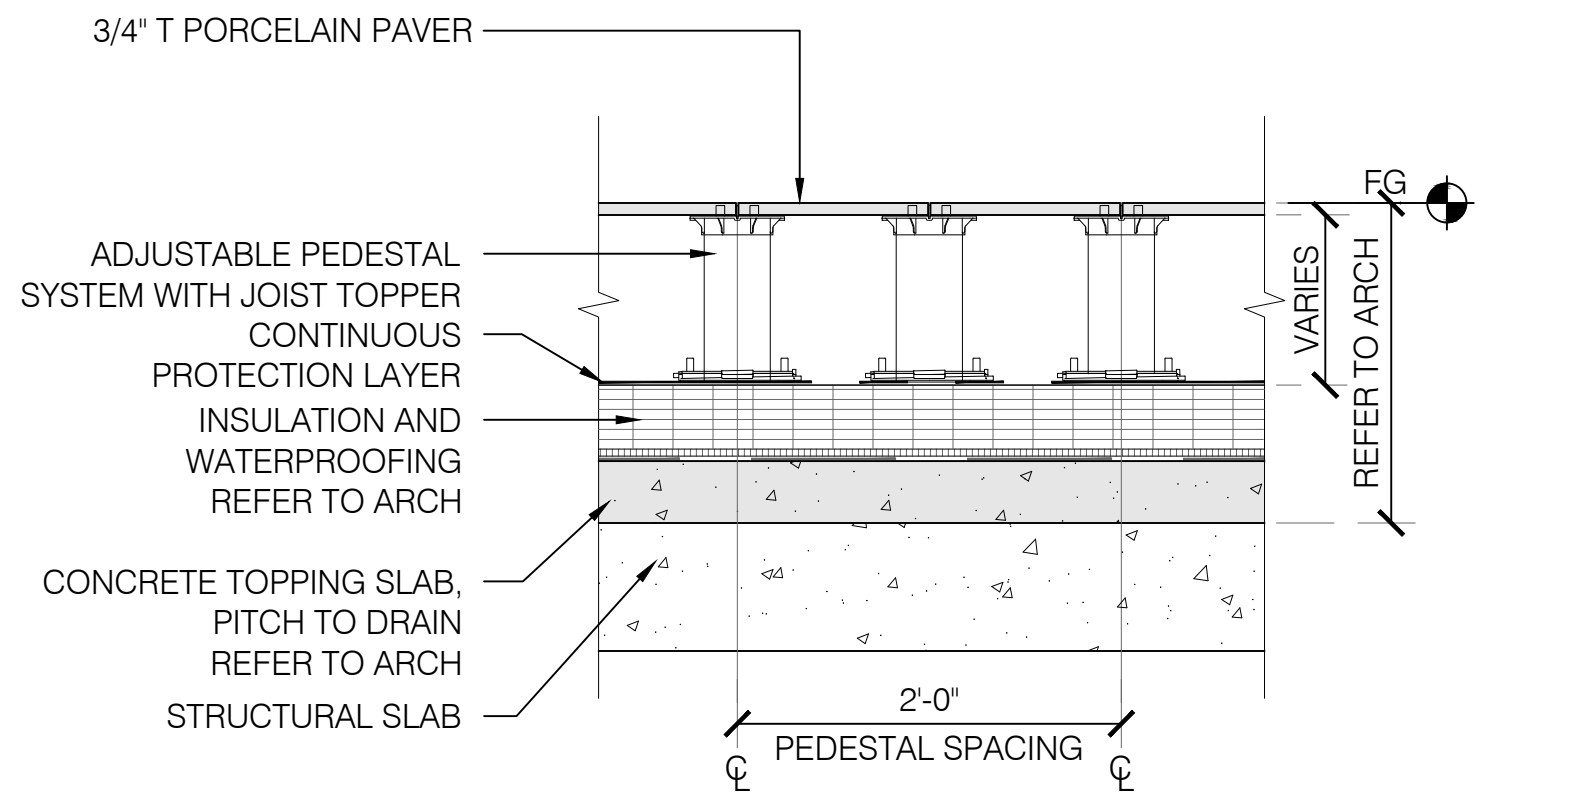

7 PAVER TYPE 5 - PORCELAIN ROOF PAVER  
1" = 1'-0"

NOTES :


1. REFER TO LAYOUT PLAN AND SPEC FOR SPECIFIED PAVER LAYOUT.
2. REFER TO GRADING PLANS FOR FG.
3. ALL PAVERT TO BE GAGUED AT FACTORY FOR 3" DEPTH.
4. REFER TO 3/LS21 FOR PERMEABLE PAVER DETAIL AT SILVA CELLS.

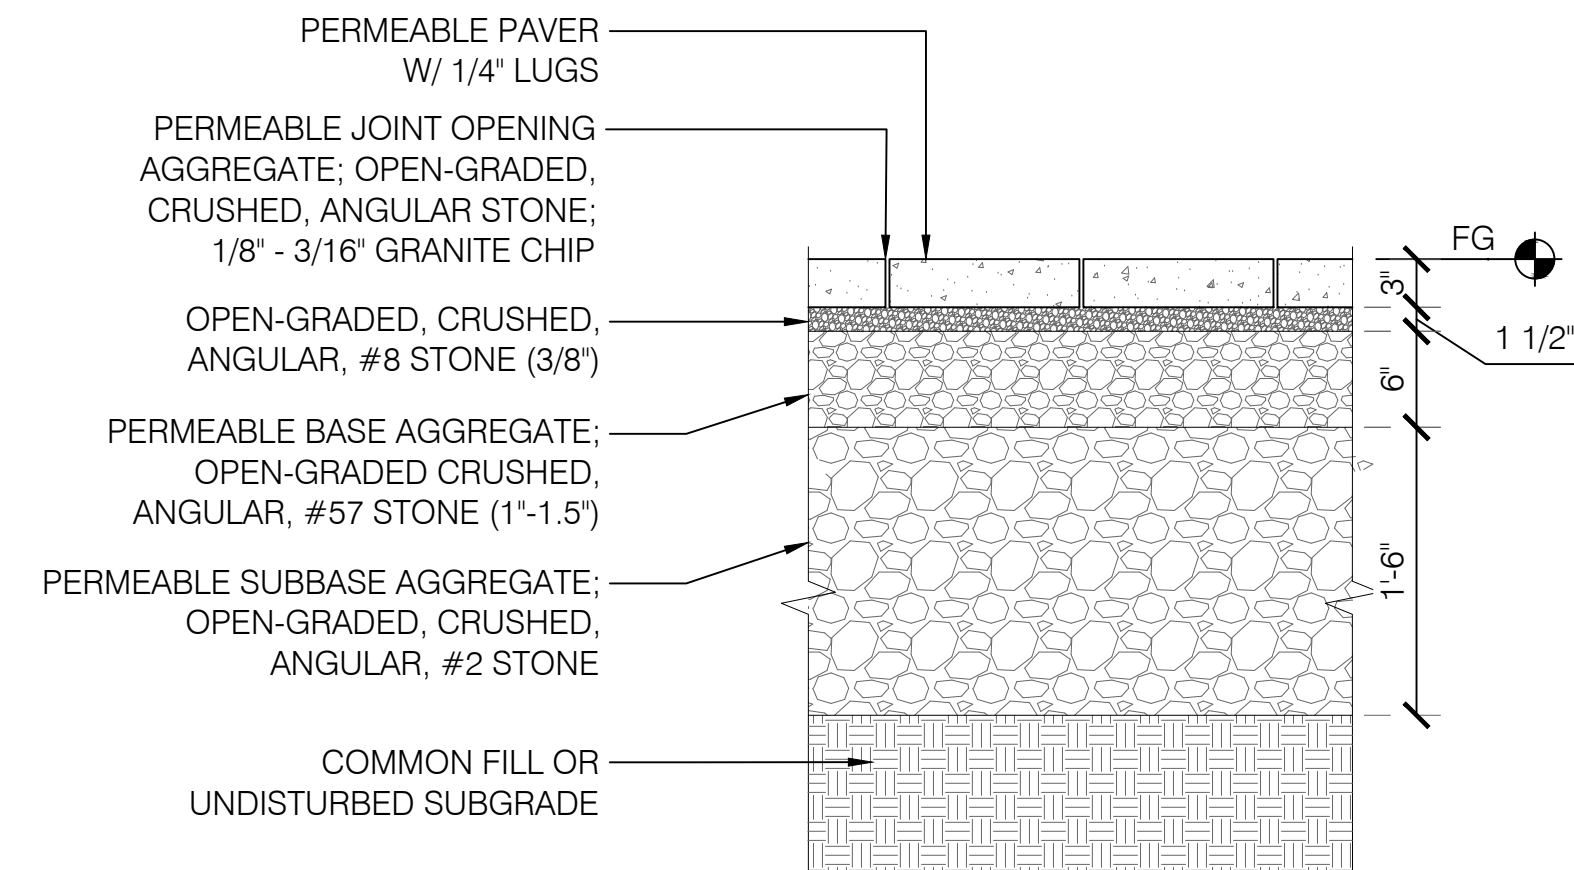

5 PAVER TYPE 2 - PERMEABLE  
1" = 1'-0"

NOTE :

1. REFER TO SPECIFICATIONS FOR CONCRETE CURING METHOD, COLOR, AND FINISH.
2. PROVIDE EXPANSION JOINTS AT TRANSITIONS BETWEEN CONCRETE BANDS AND AT ALL VERTICAL ELEMENTS.
3. PROVIDE TOOLED JOINT ALONG MARGIN OF ALL SURFACE FLUSH STRUCTURES, SUCH AS MANHOLE VAULTS, AND DRAINS.

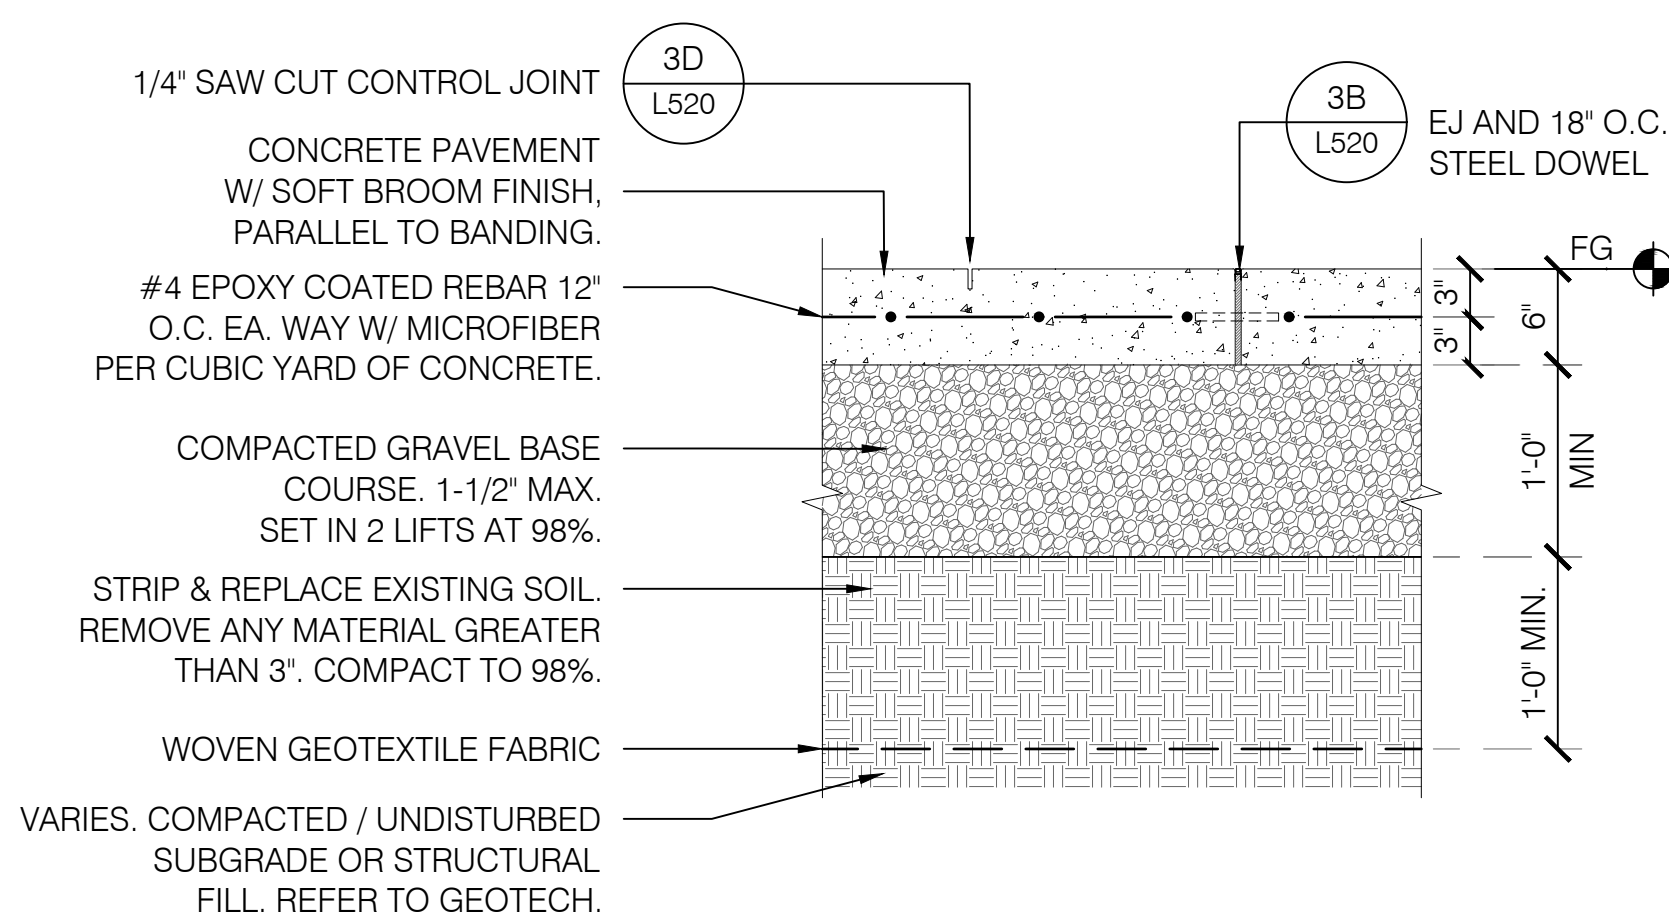


1 PAVEMENT TYPE 1 - VEHICULAR CONCRETE  
1" = 1'-0"


NOTE :

1. REFER TO LAYOUT AND MATERIALS PLANS FOR CONTROL JOINT (CJ) AND EXPANSION JOINT (EJ) LOCATIONS.
2. PROVIDE FULL DEPTH EJ AT ALL VERTICAL ELEMENTS AND MATERIAL TRANSITIONS.
3. SAWCUTS TO BE CONTINUOUS AND FREE OF ANY IRREGULARITIES. EXTENT OF SAWCUT SHALL MEET ALL PERPENDICULAR JOINTS, JOINTS WHICH FALL SHORT ARE NOT ACCEPTABLE.
4. TOOLED EDGES OF PAVEMENT AND JOINTS IN CONCRETE ARE UNACCEPTABLE. PROVIDE FINISH TO JOINT EDGE.

A - EXPANSION JOINT

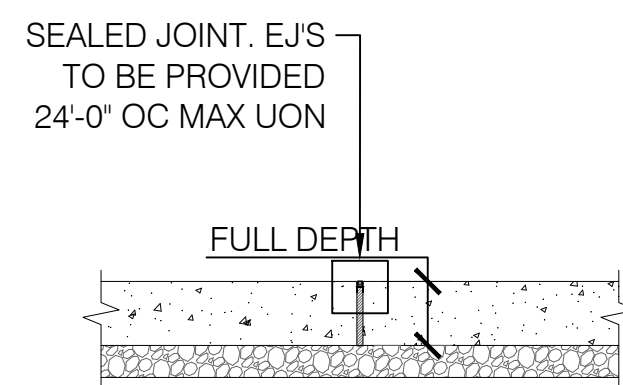


C - SEALED JOINT ENLARGEMENT

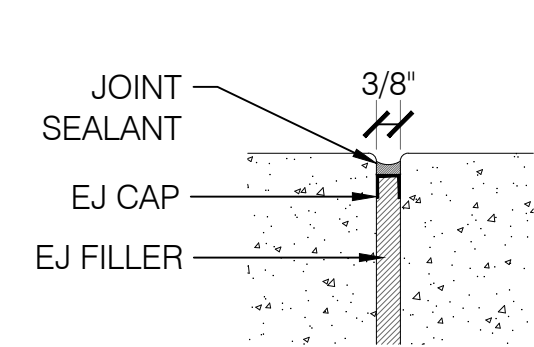


3 CONCRETE JOINTING  
1" = 1'-0"

B - DOWELED EXPANSION JOINT

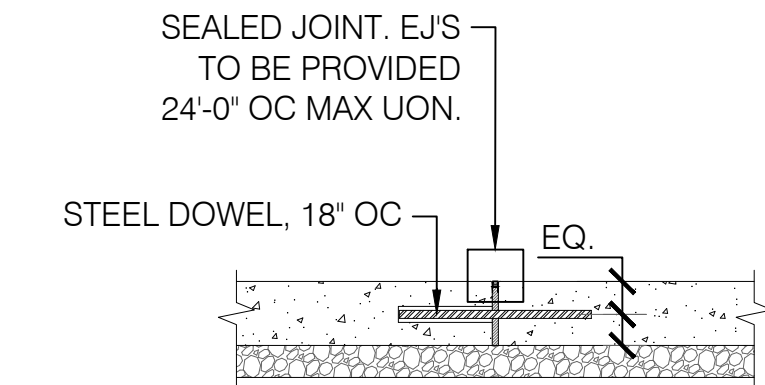


D - SAW CUT CONTROL JOINT

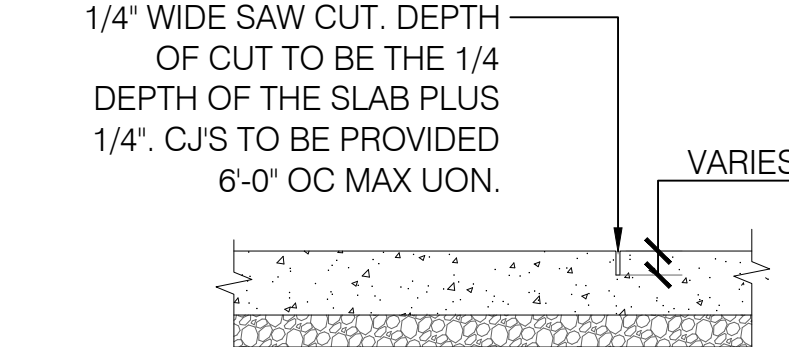

2 PAVING TYPE 2 - STANDARD SIDEWALK  
1" = 1'-0"

NOTE :

1. REFER TO LAYOUT PLAN AND SPEC FOR SPECIFIED PAVER LAYOUT.
2. REFER TO GRADING PLANS FOR FG.
3. ALL PAVERT TO BE GAGUED AT FACTORY FOR 3" DEPTH

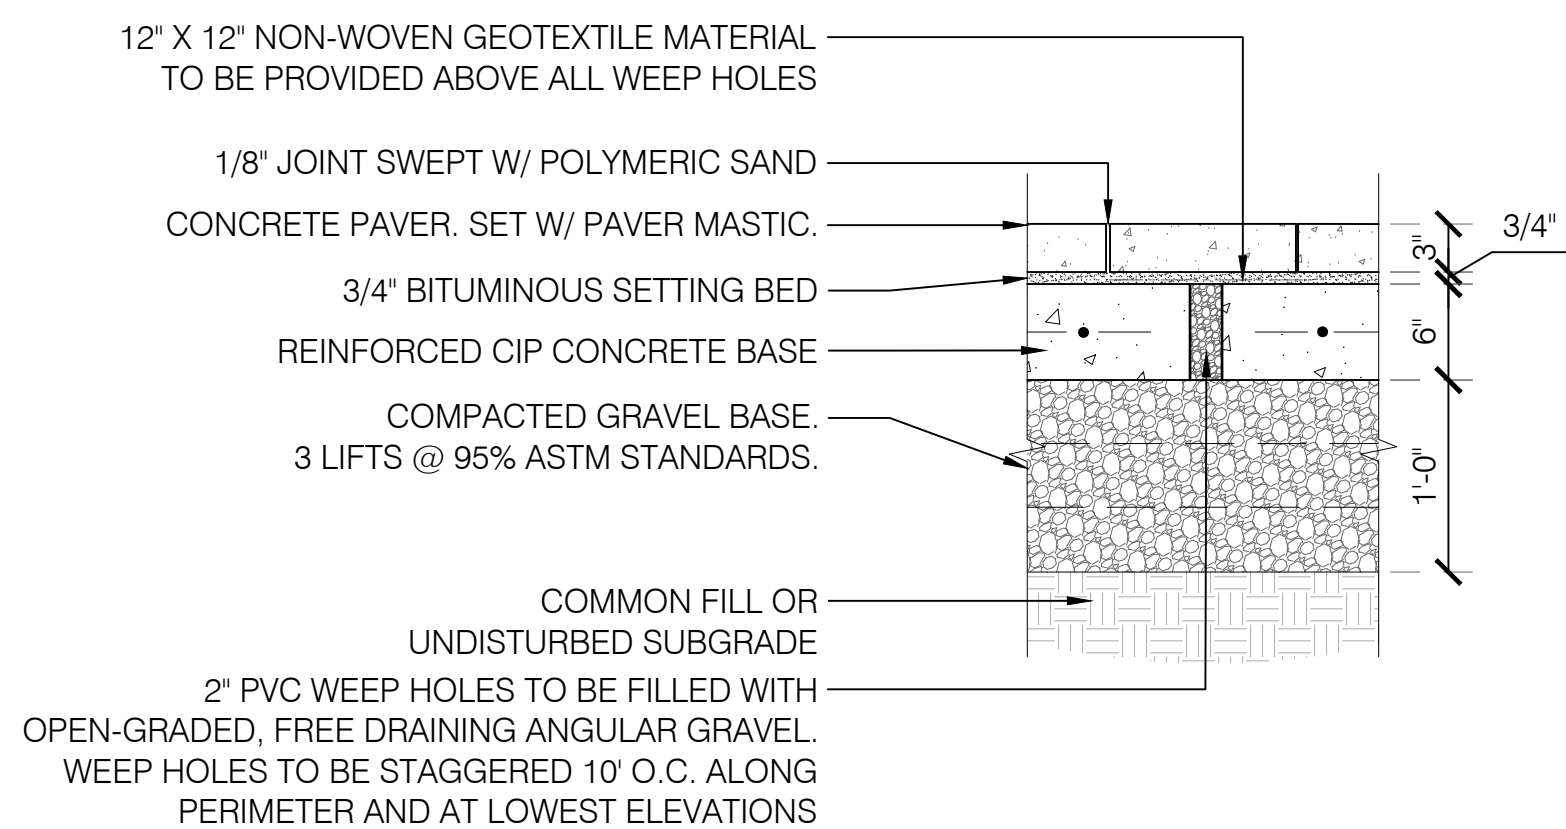

4 PAVER TYPE 1 - VEHICULAR  
1" = 1'-0"



## 74 Middlesex

74 Middlesex Ave  
Somerville, MA 02145

### Client

Graystar  
One Federal Street, Suite 1804  
Boston / MA / 02110

### Geotechnical Engineer

Halley Aldrich  
70 Blanchard Rd #204  
Burlington / MA / 01803

### Civil Engineer

VHB  
99 High Street, 10th Floor  
Boston / MA / 02110

### Landscape Architect

Mikyoun Kim Design  
119 Brantree St #103  
Boston / MA / 02134

### Structural Engineer

McNamara/Salvia  
101 Federal Street  
Boston / MA / 02110

### MEP Engineer

BR A  
10 Guest Street, 4th Floor  
Boston / MA / 02135

### Code Consultant

Jensen Hughes  
1661 Worcester Road, Suite 501  
New Haven / CT / 01701

### LEED / Environmental Consultant

Akalis Ten

45 East 20th Street

New York / NY / 10003

### Building Envelope Consultant

Heintges

440 Park Avenue South, 15th Floor

New York, NY - 10018

### Elevator Consultant

VDA

101 Summer Street, 4th Floor

Boston / MA / 02110

### Parking Consultant

DESMAN, Inc.

18 Tremont Street #300

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SCALE:

AS NOTED

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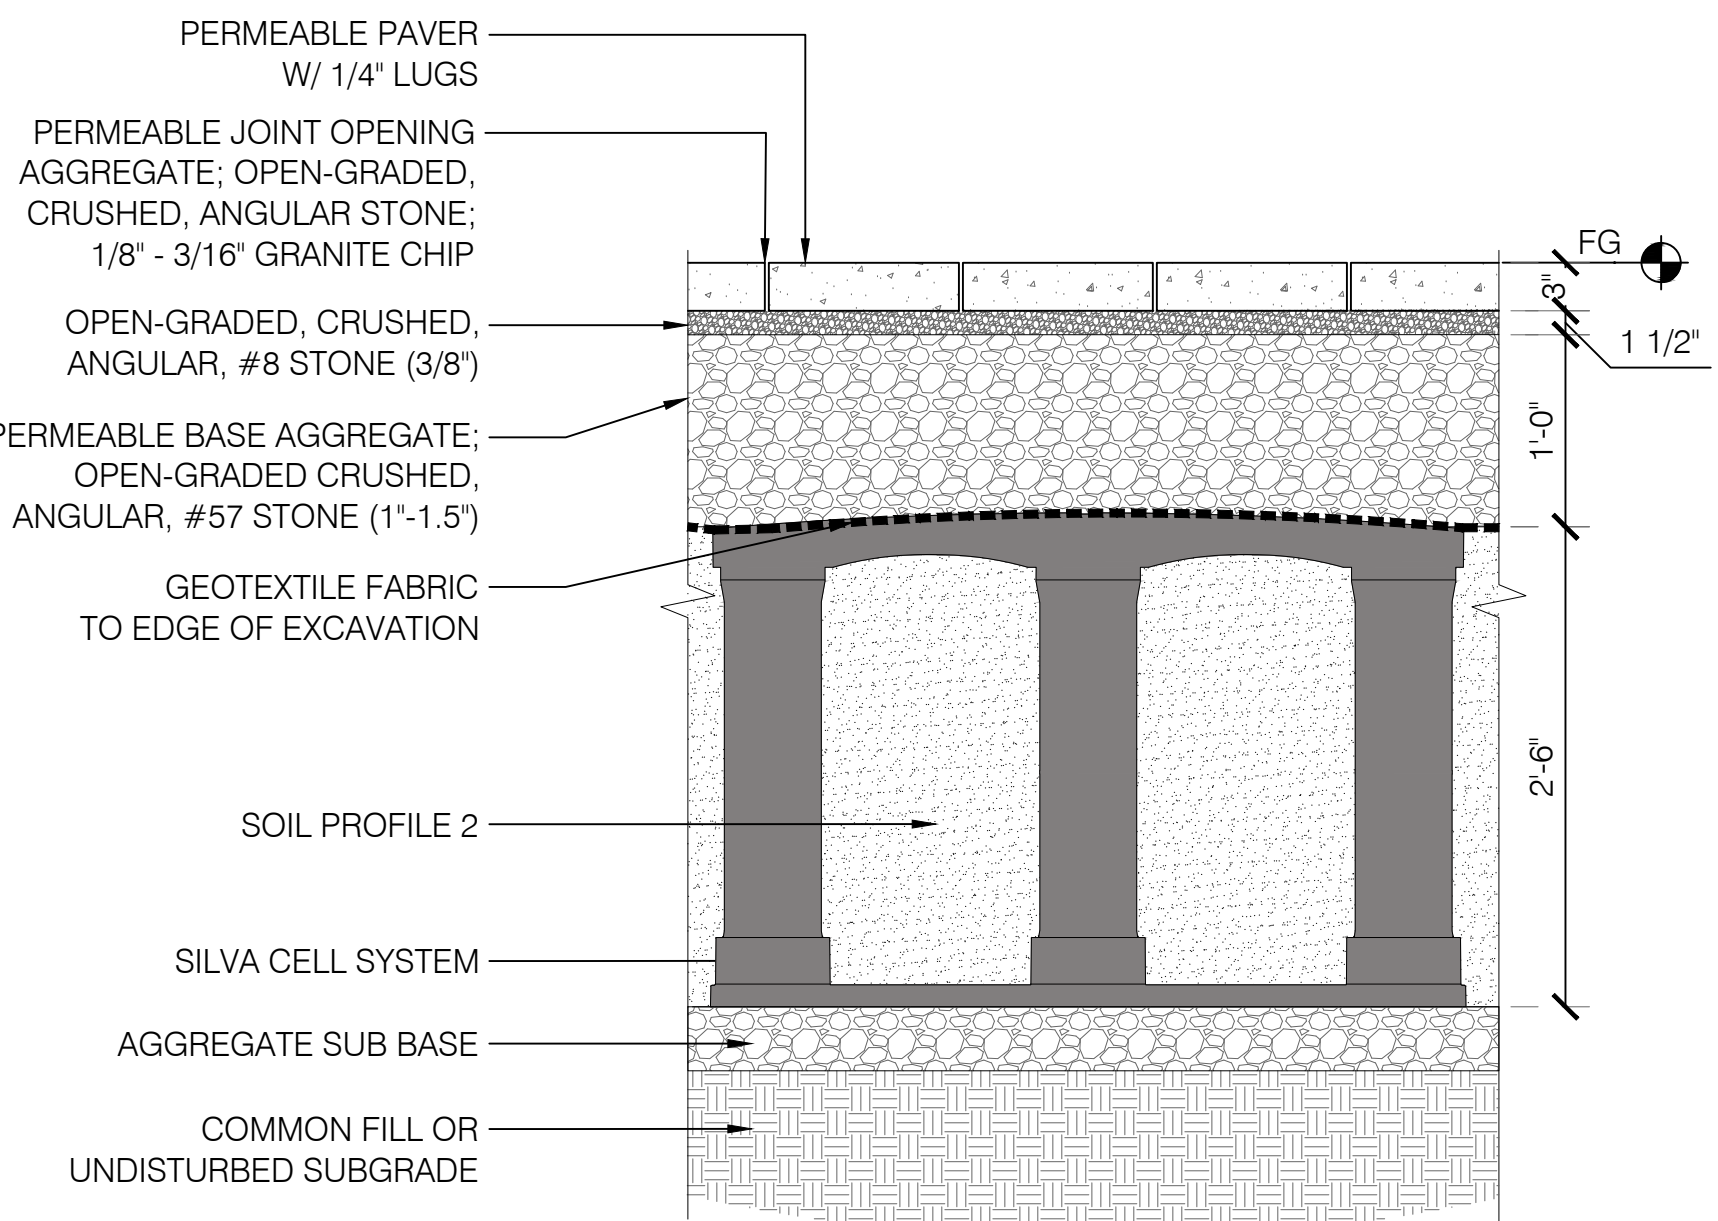
PAVING AND CURBING  
DETAILS

DRAWING NUMBER:

# GS.9

### NOTES :

1. REFER TO LAYOUT PLAN AND SPEC FOR SPECIFIED PAVER LAYOUT.
2. REFER TO GRADING PLANS FOR FG.




- 3 PAVERTYPE 3 AT SILVA CELLS  
1" = 1'-0"


VIEW

### NOTES :

1. ALL JOINTS BETWEEN CURBING SECTIONS SHALL BE 1/4". FILL FULL WITH MORTAR.
2. ALIGN CURB JOINTS WITH ADJACENT PAVEMENT JOINTING.
3. REFER TO CURB SPECIFICATIONS FOR FINISH AND COLOR.
4. ADJACENT CONDITION VARIES, REFER TO LAYOUT & MATERIALS PLAN.

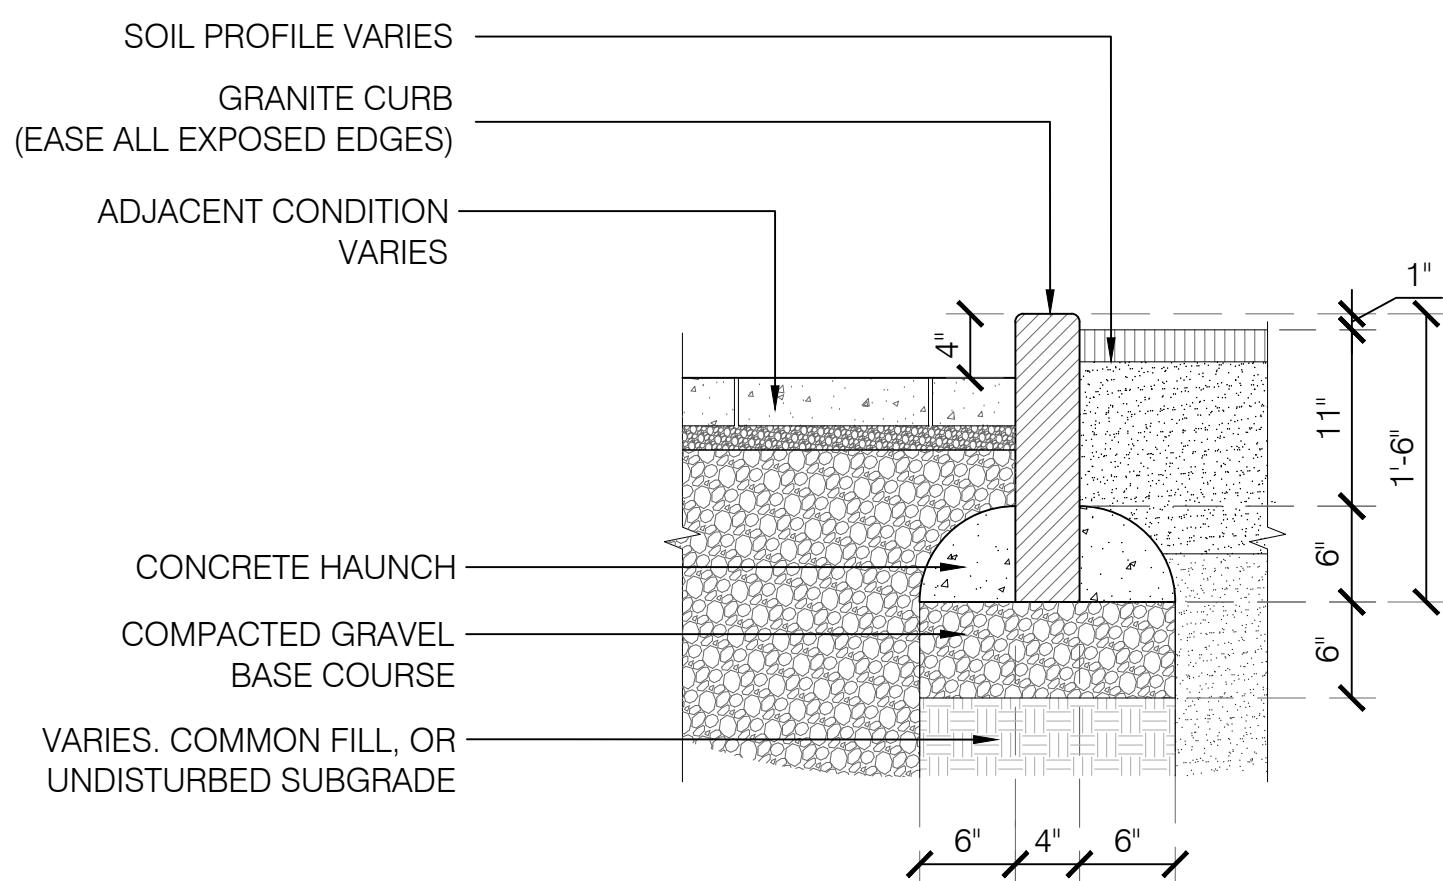

A - TYPICAL

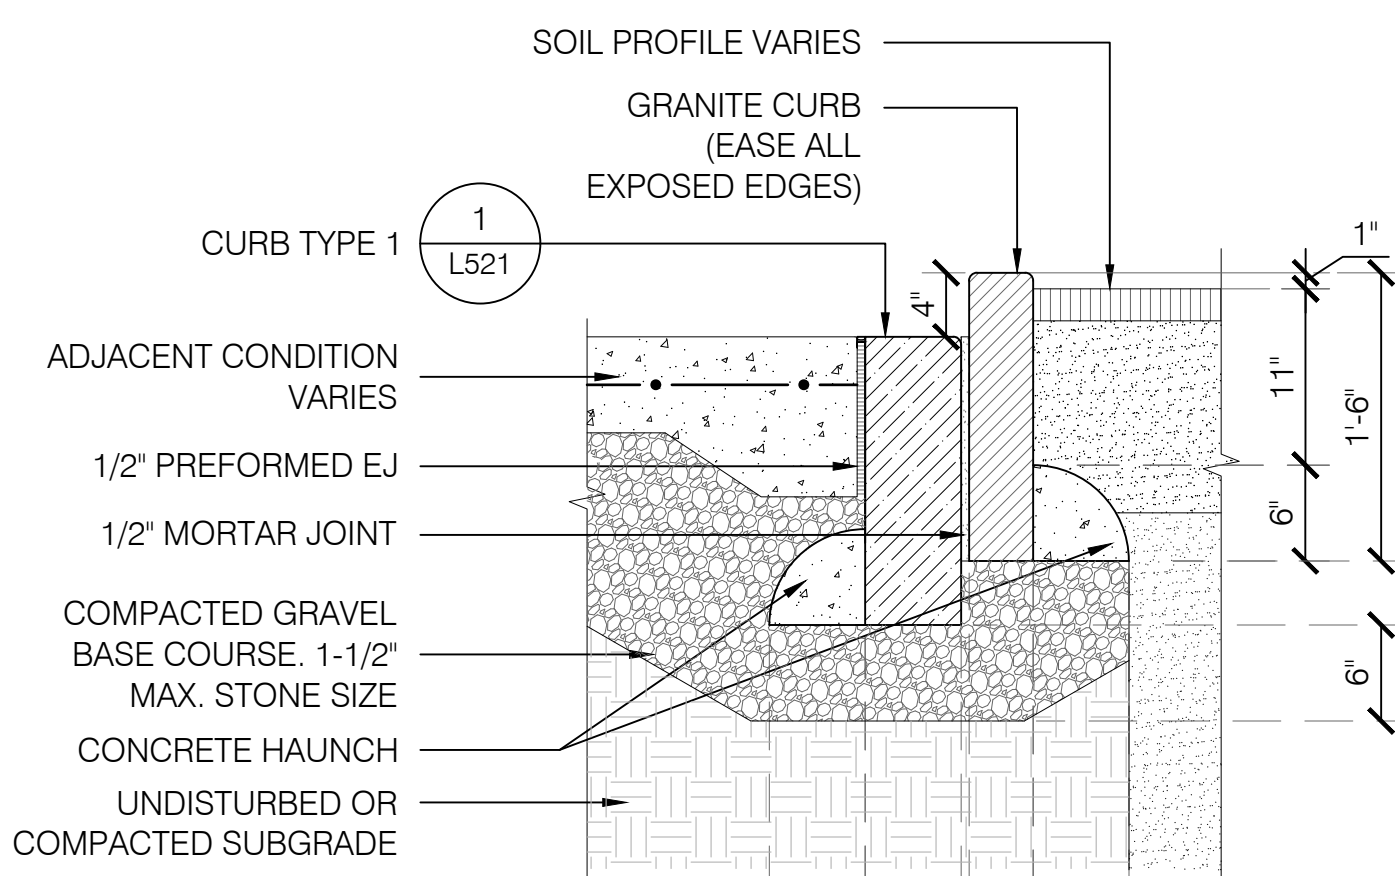


B - AT CURB TYPE 1


SECTION

### NOTES :

1. ALL JOINTS BETWEEN CURBING SECTIONS SHALL BE 1/4". FILL FULL WITH MORTAR.
2. ALIGN CURB JOINTS WITH ADJACENT PAVEMENT JOINTING.
3. REFER TO CURB SPECIFICATIONS FOR FINISH AND COLOR.
4. ADJACENT CONDITION VARIES, REFER TO LAYOUT & MATERIALS PLAN.

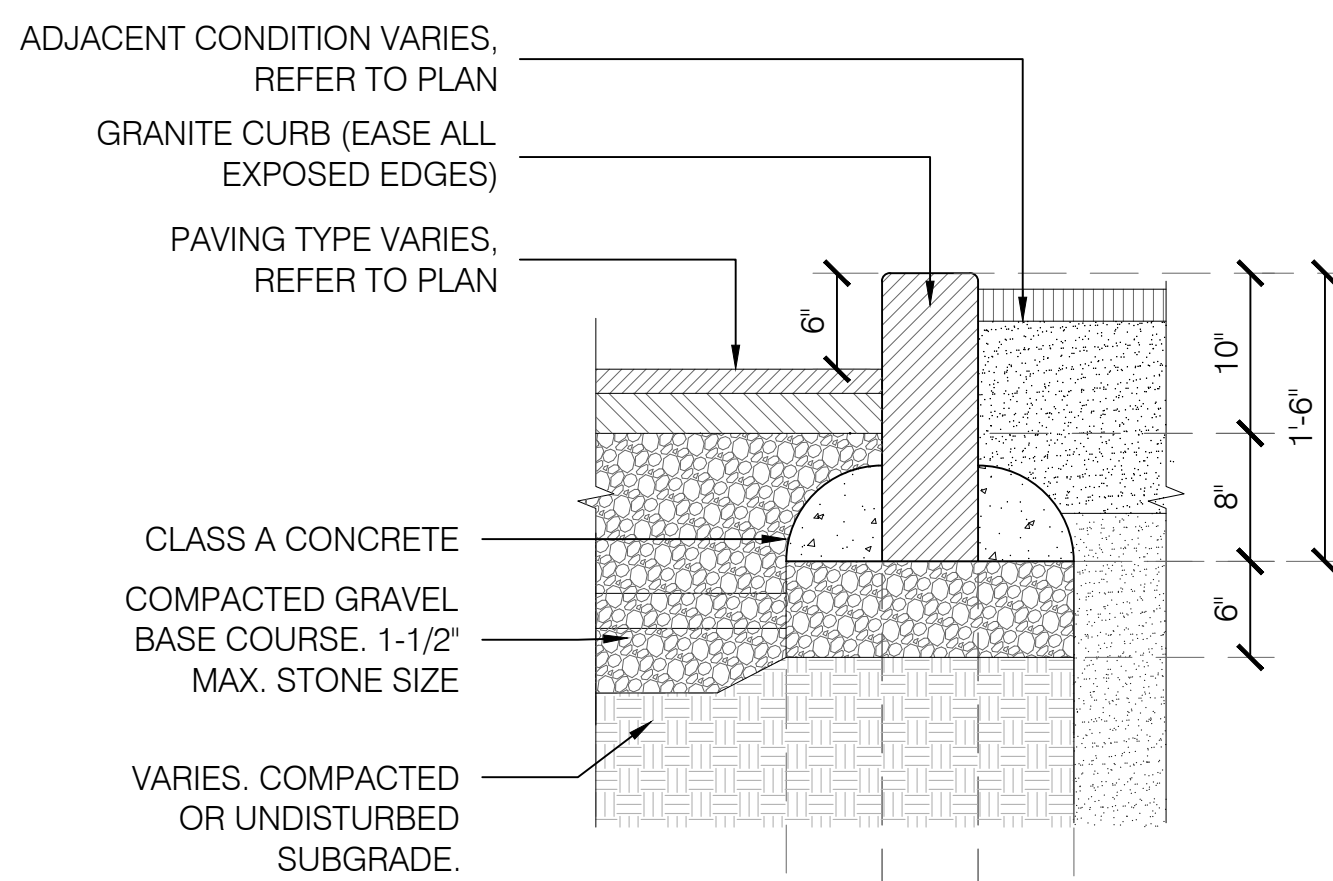

A - TYPICAL

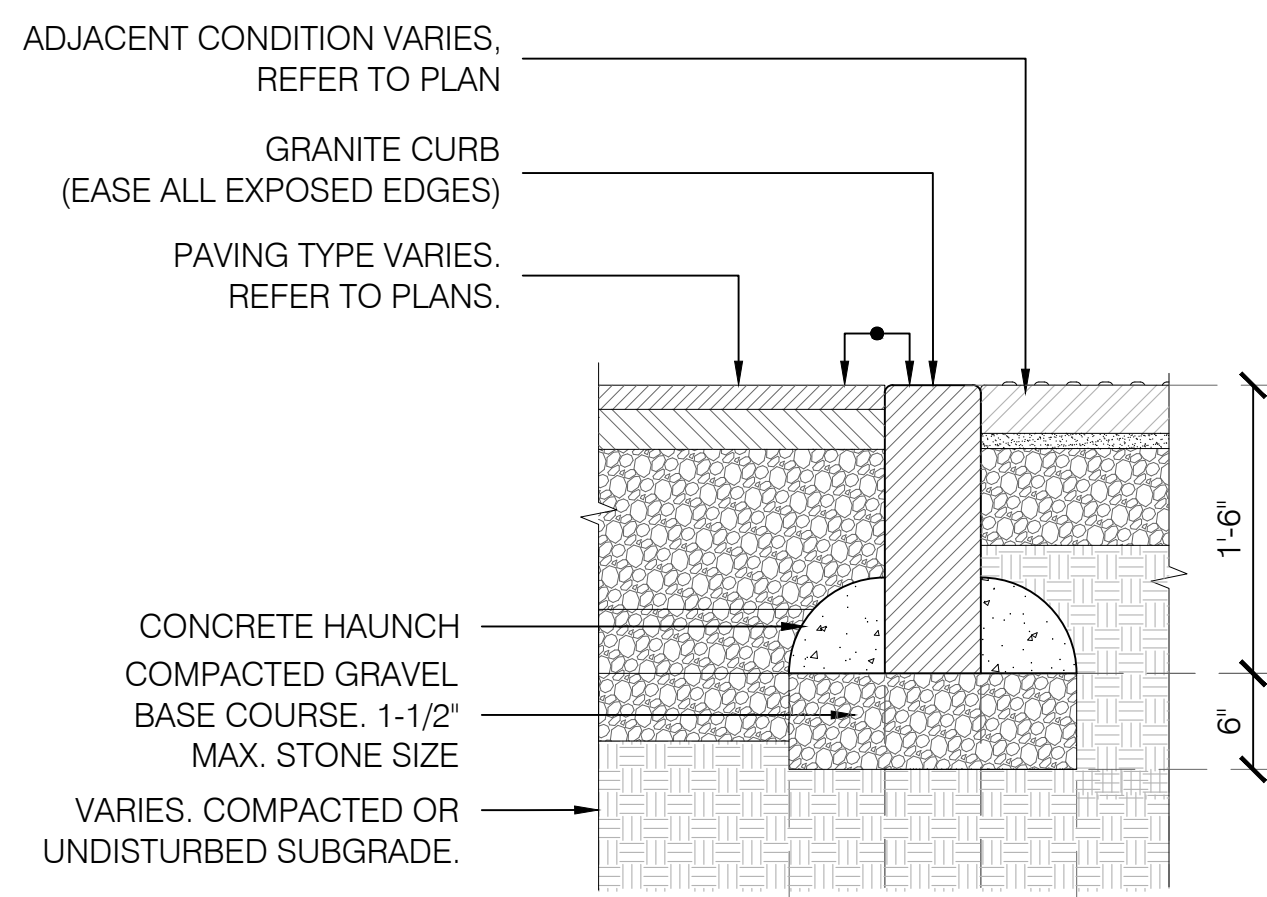

B - FLUSH

SECTION

NOT FOR CONSTRUCTION